

## ERECT A 3 STORY, IIIB MASONRY 4 UNIT BUILDING WITH BASEMENT AND DETACHED 4 CAR GARAGE

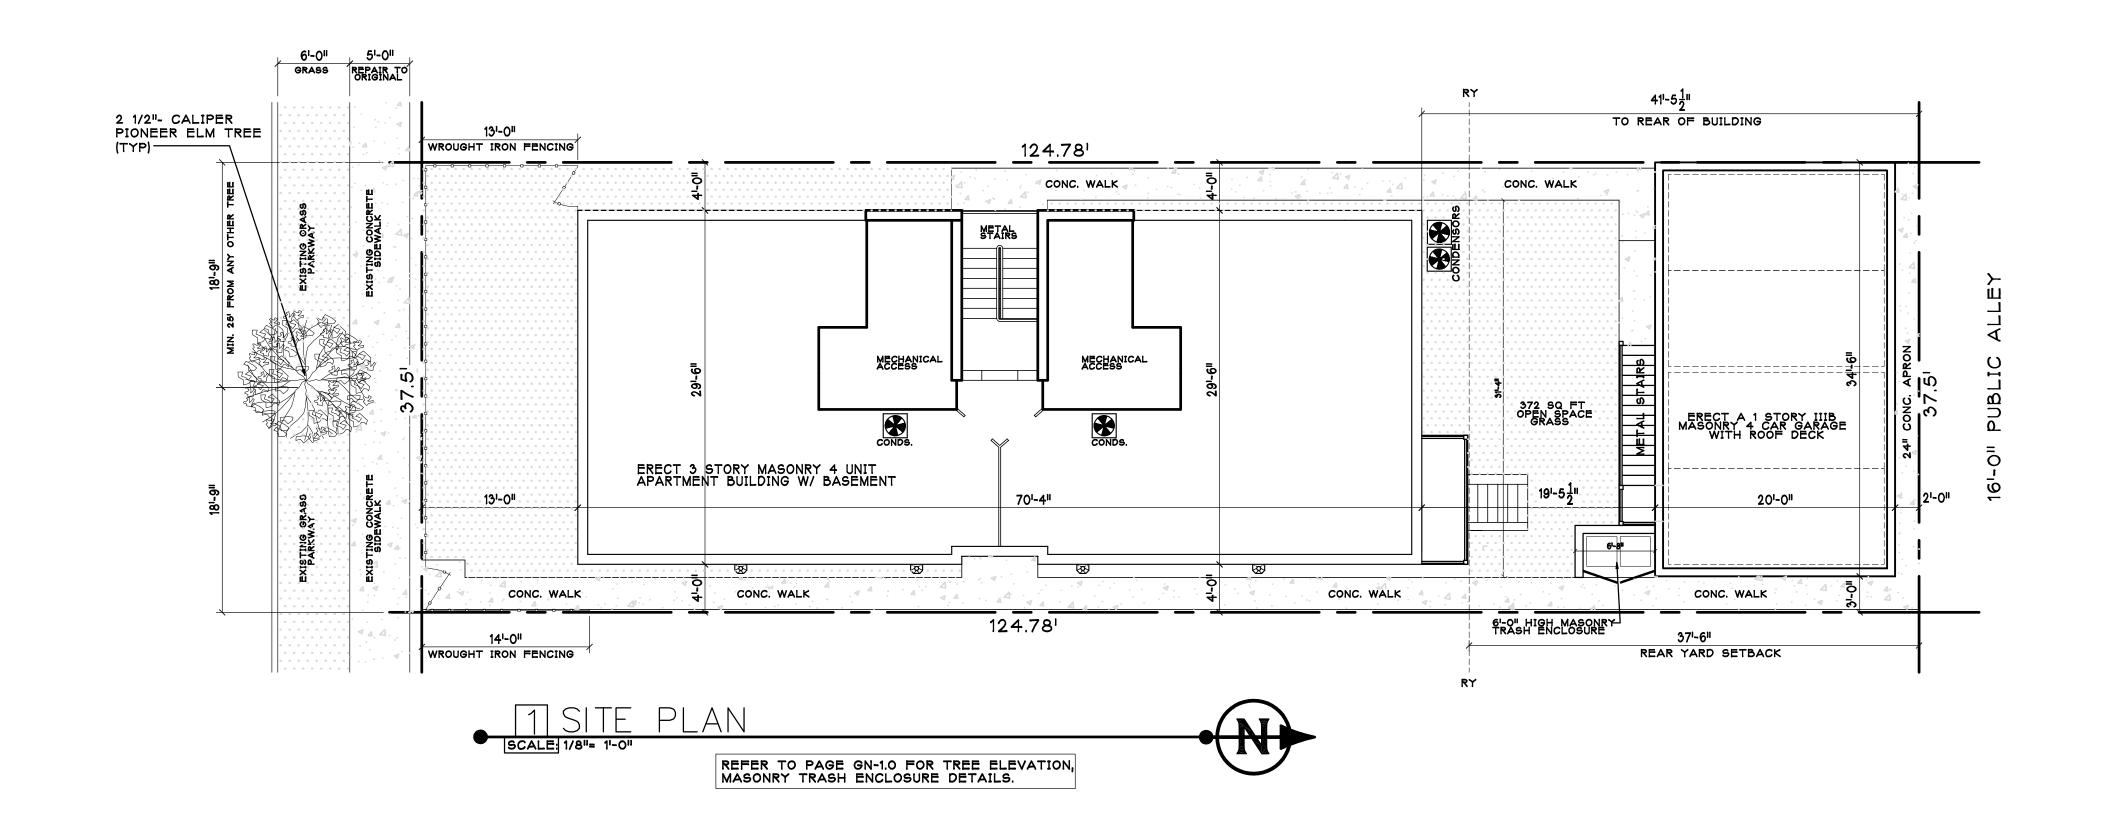



SELF CERTIFICATION

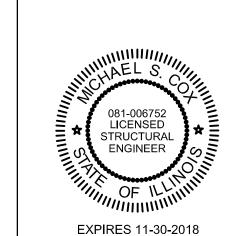

No. Revision/Issue Date			
No. Revision/Issue Date		PERMIT	8/18
No. Revision/Issue Date			
No. Revision/Issue Date			
No. Revision/Issue Date			
	No.	Revision/Issue	Date

## MC & Associates,

120 W. MADISON SUITE 310 CHICAGO, IL 60602

PROJECT:


PROJECT #:

SCALE: AS NOTED

ERECT A NEW MASONRY 4 UNIT BUILDING W/ BASEMENT


DRAWING TITLE


DRAWING #:

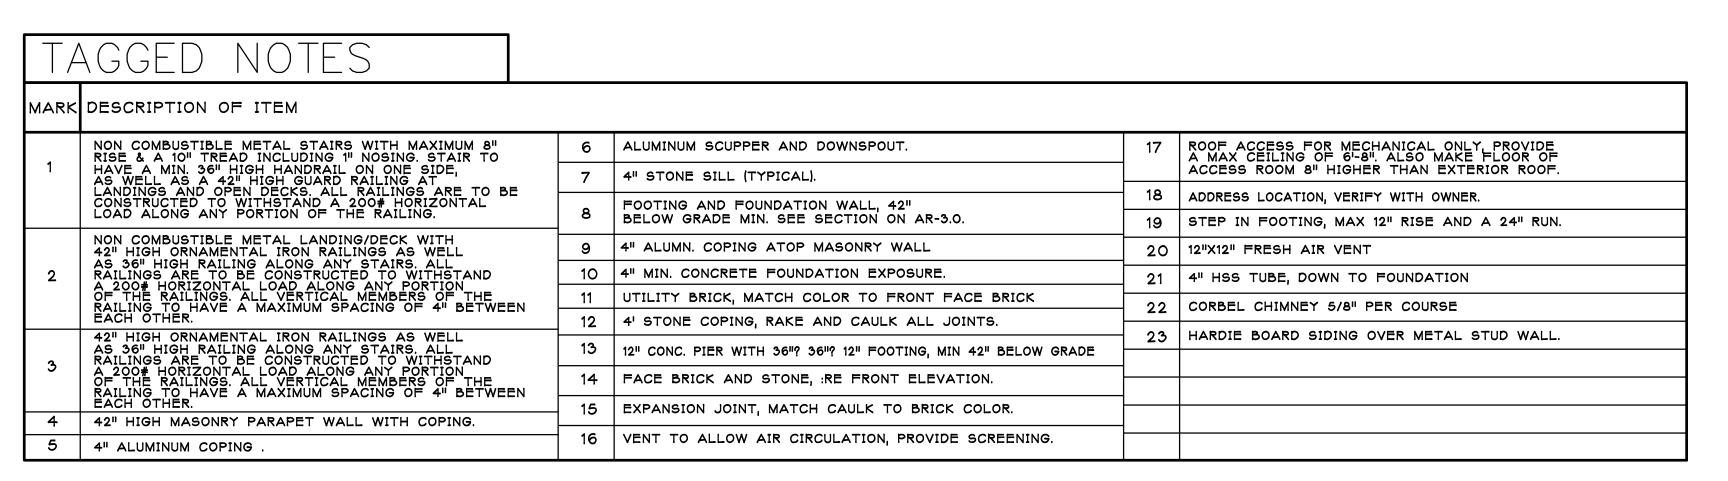



RT-4 - ERECT A NEW (3) STORY (4) D.U.
BUILDING W/ BASEMENT, ROOFTOP
STAIRWAY ENCLOSURES, OPEN DECKS, SIDE
OPEN PORCH, REAR OPEN PORCH, TRASH
ENCLOSURE, FENCES, AND A DETACHED (4)
CAR GARAGE W/ ROOF DECK. 11/6/18

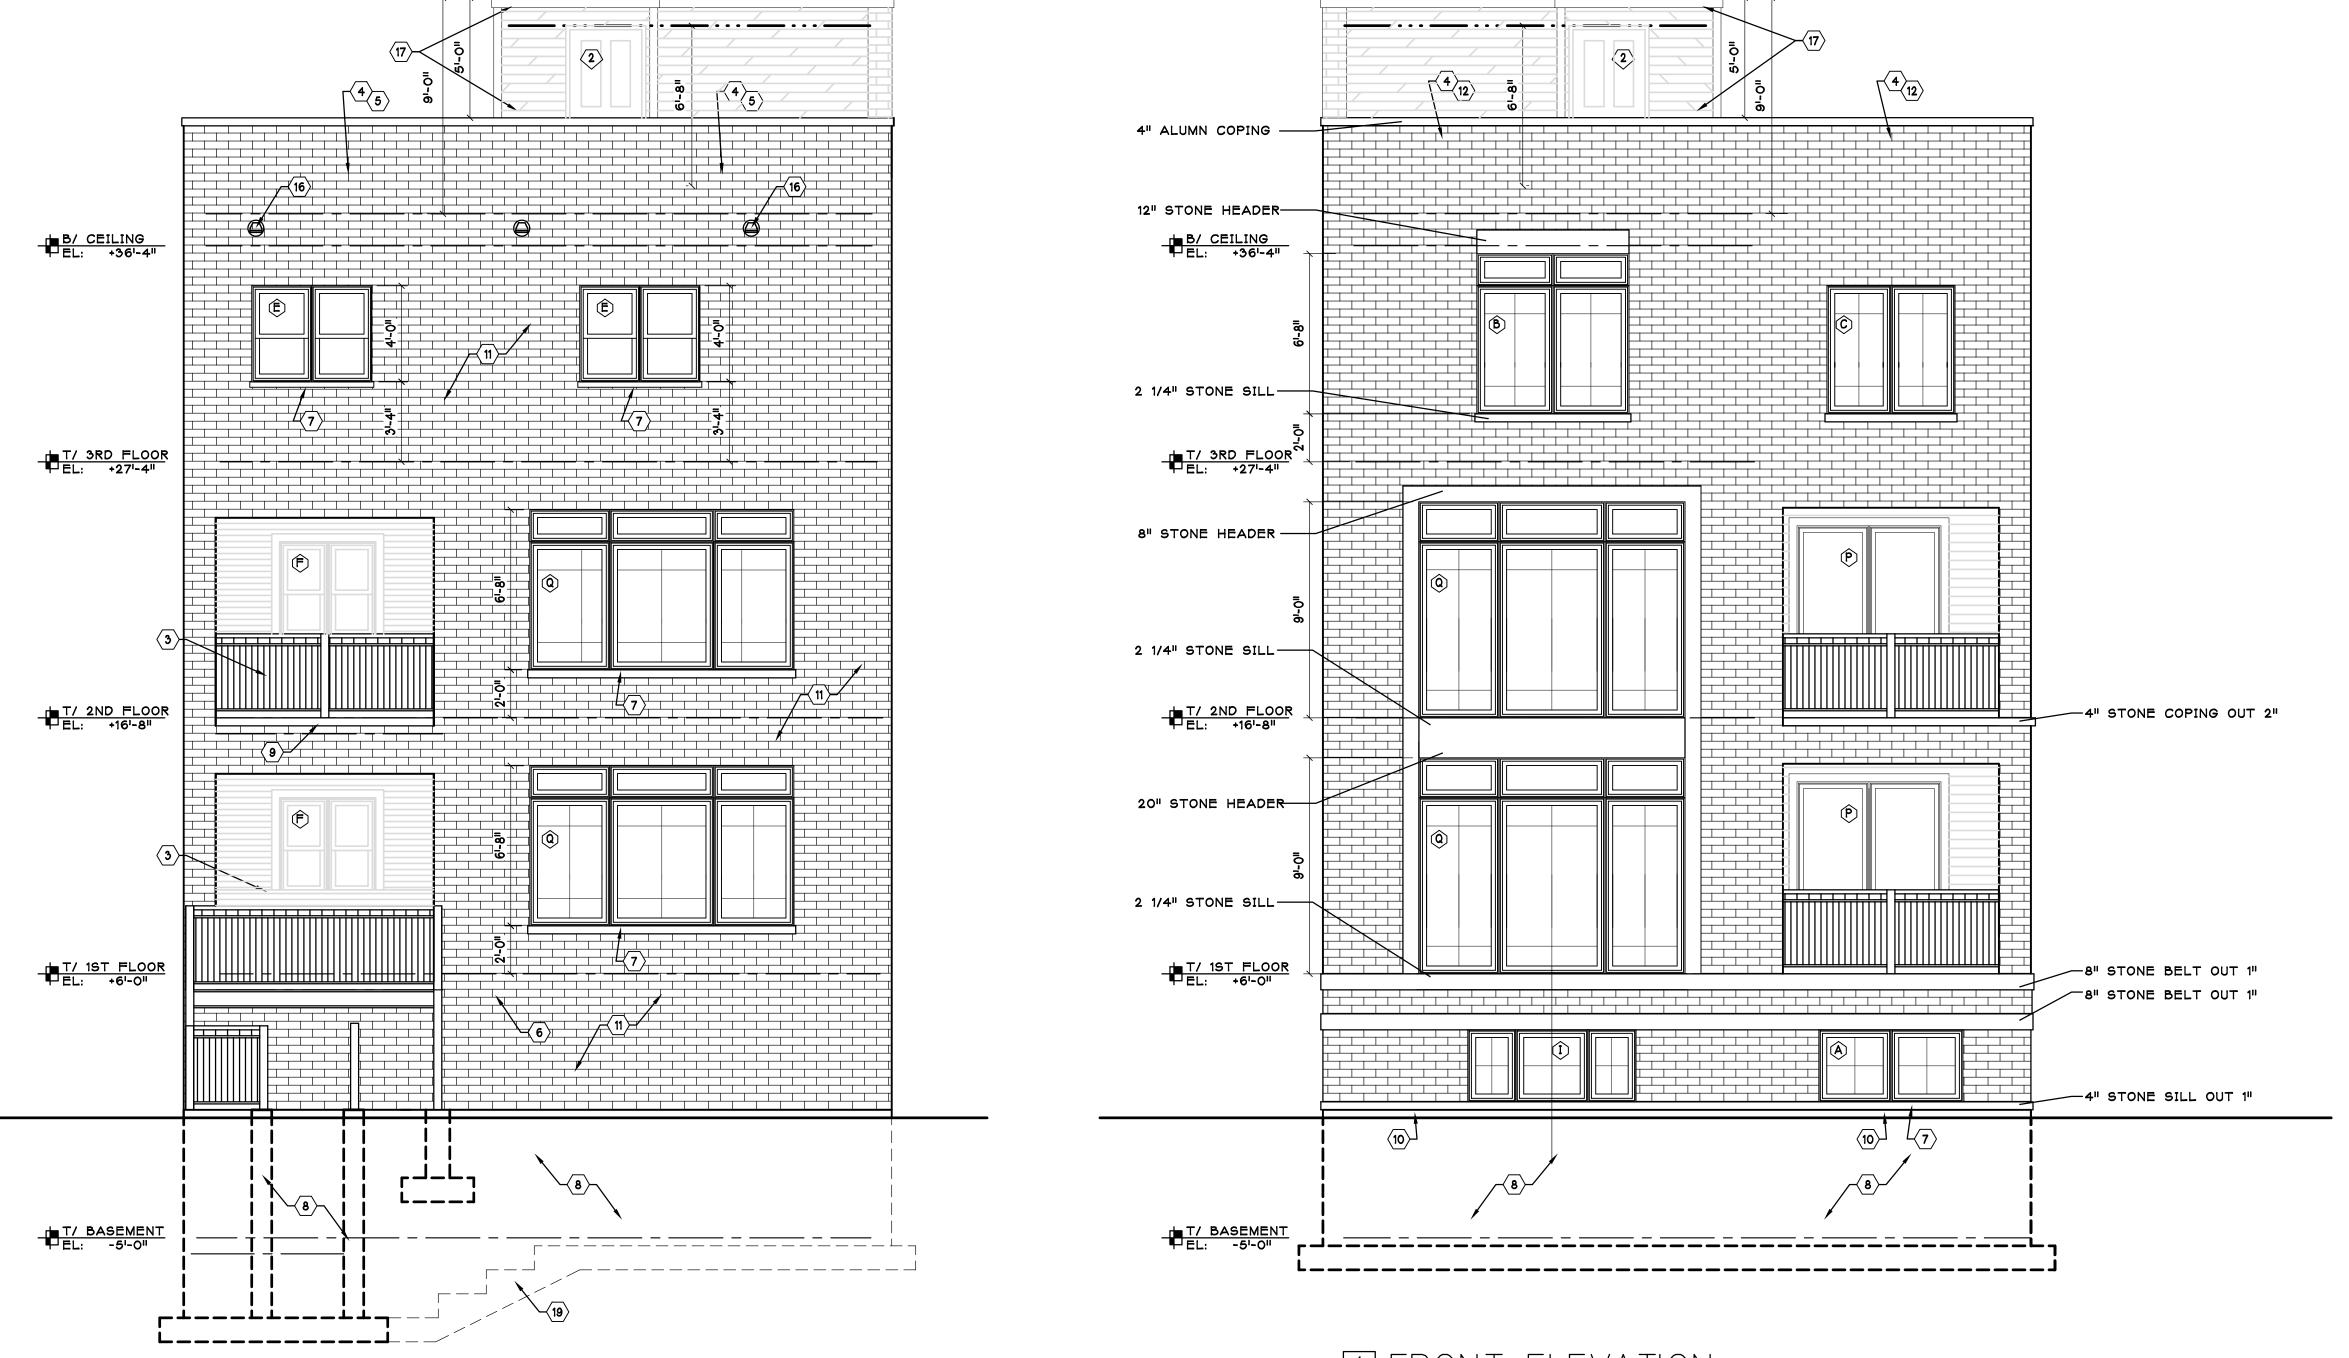

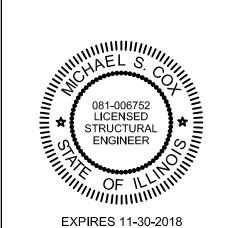

STANDARD PLAN REVIEW
CONDITIONAL

PERMIT

Construction subject to full compliance with the Municipal Code of Chicago and field inspection

SELF

CERTIFICATION

By Elect Oakty

	PERMIT	8/18
No.	Revision/Issue	Date


## MC & Associates,

120 W. MADISON SUITE 310 CHICAGO, IL 60602

PROJECT:

ERECT A NEW MASONRY 4 UNIT BUILDING W/ BASEMENT

PROJECT #:	DRAWING TITLE:
GP	
DATE:	
7/18	DRAWING #:
SCALE:	
AS NOTED	AR-1./

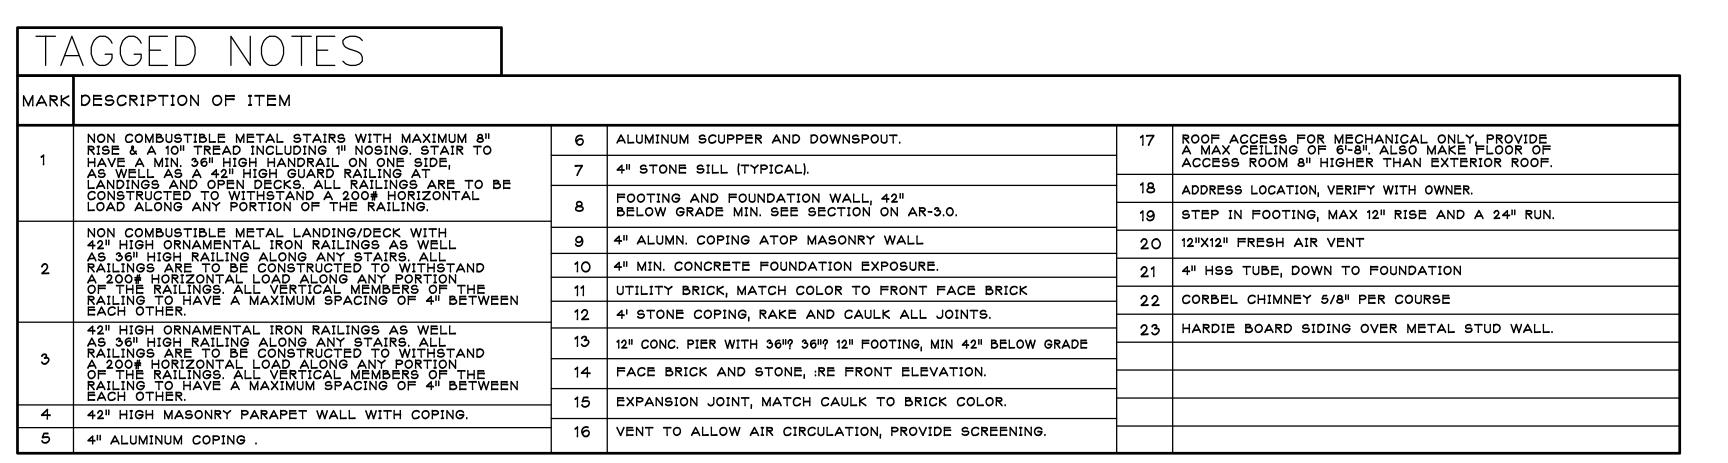



RT-4 - ERECT A NEW (3) STORY (4) D.U.
BUILDING W/ BASEMENT, ROOFTOP
STAIRWAY ENCLOSURES, OPEN DECKS, SIDE
OPEN PORCH, REAR OPEN PORCH, TRASH
ENCLOSURE, FENCES, AND A DETACHED (4)
CAR GARAGE W/ ROOF DECK. 11/6/18




STANDARD PLAN REVIEW
CONDITIONAL
PERMIT
Construction subject to full compliance with the Municipal Code of Chicago and field inspection

Building Commissioner

Eduf Outt

SELF CERTIFICATION

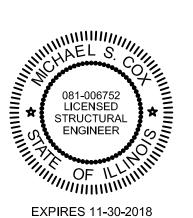

	PERMIT	8/18
No.	Revision/Issue	Date

MC & Associates,

120 W. MADISON SUITE 310 CHICAGO, IL 60602

PROJECT:

ERECT A NEW MASONRY 4 UNIT BUILDING W/ BASEMENT

PROJECT #: DRAWING TITLE:

GP


DATE:


7/18

SCALE:
AS NOTED

DRAWING #:

AR — 1.5

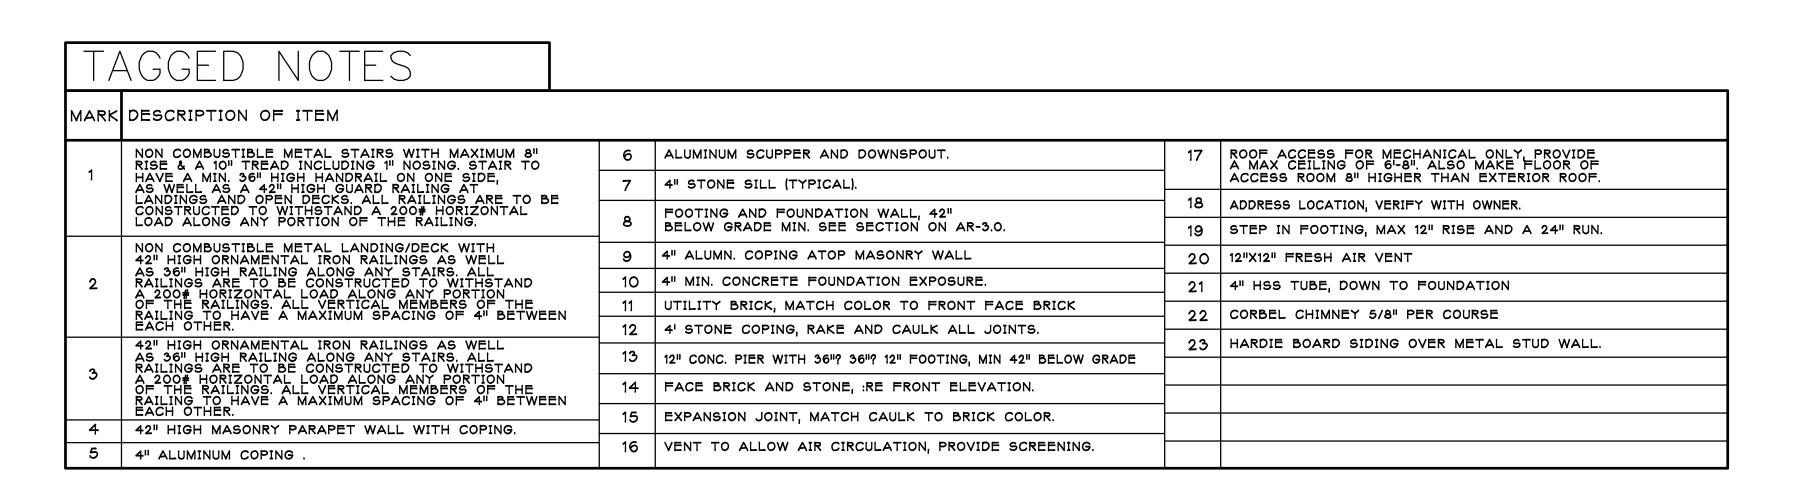

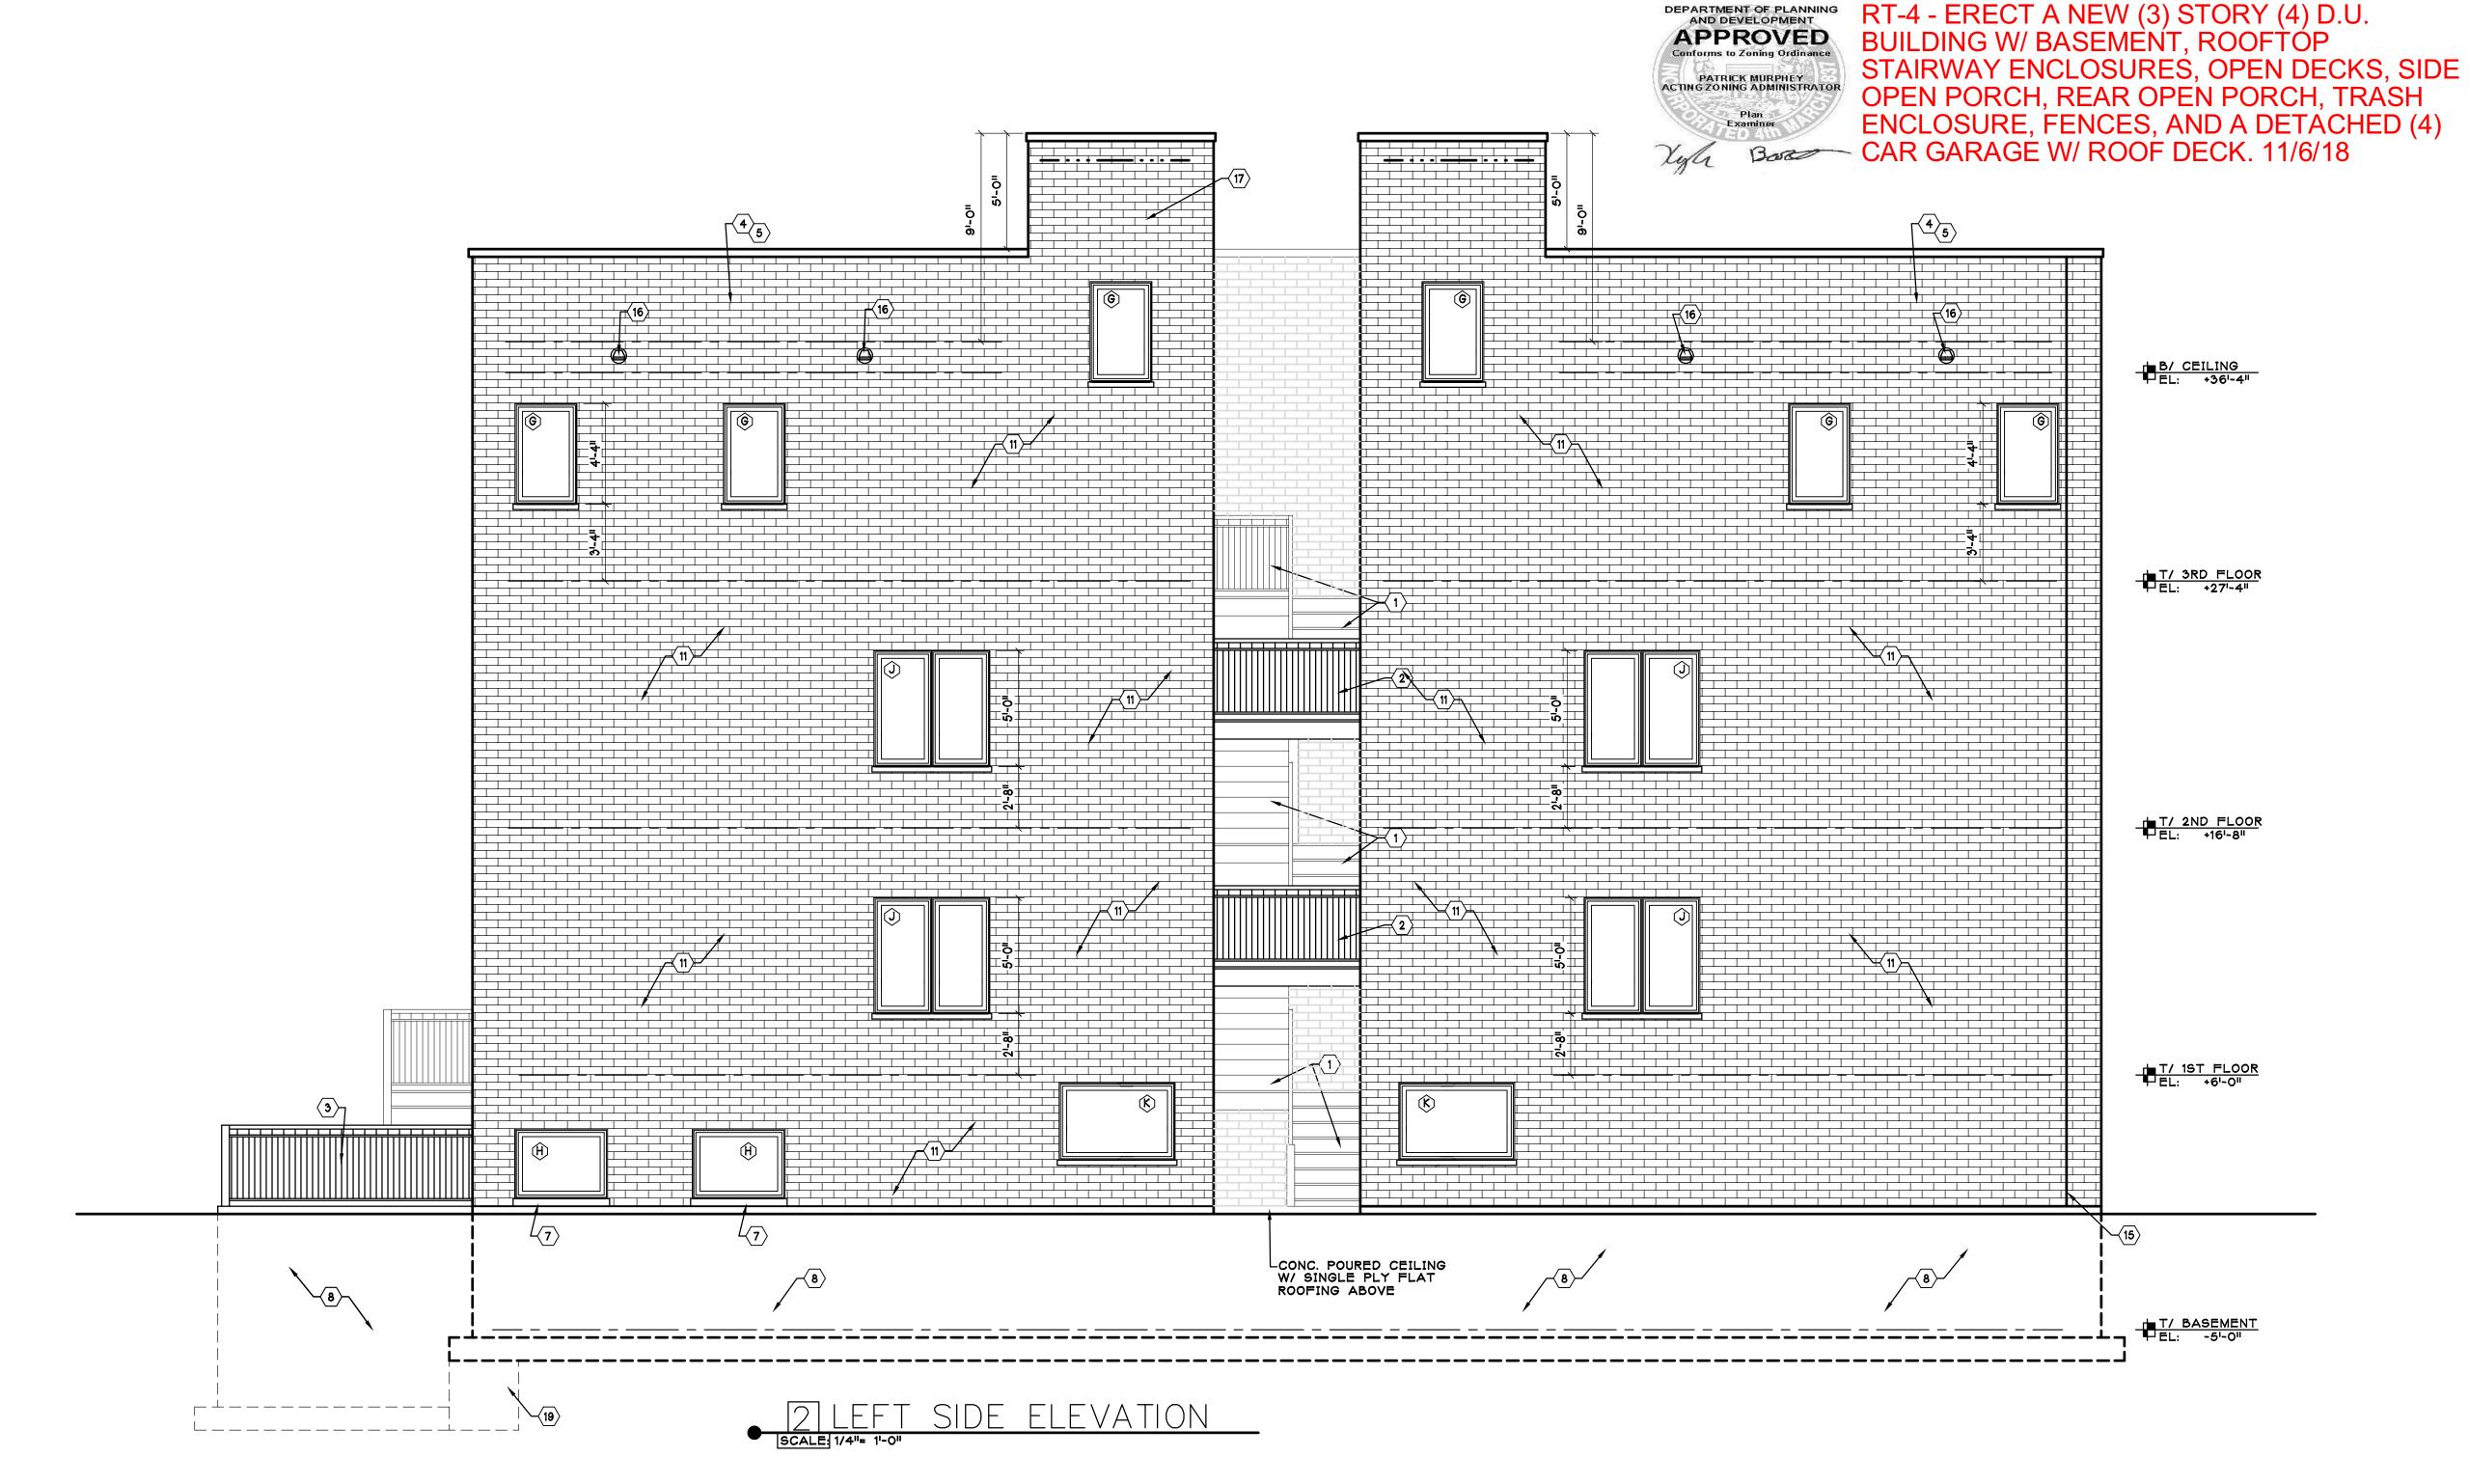

DEPARTMENT OF BUILDINGS

STANDARD PLAN REVIEW

CONDITIONAL

PERMIT

Construction subject to full compliance with the Municipal Code of Chicago and field inspection

Building

SELF

CERTIFICATION

By Edut Osty

081-006752
LICENSED
STRUCTURAL
ENGINEER
OF ILLINIA

	PERMIT	8/18
No.	Revision/Issue	Date
	-	

MC & Associates,

120 W. MADISON SUITE 310 CHICAGO, IL 60602

PROJECT:

ERECT A NEW MASONRY 4 UNIT BUILDING W/ BASEMENT

PROJECT#:	DRAWING TITLE:
GP	
DATE:	
7/18	DRAWING #:
SCALE:	
AS NOTED	IAR-1.6

WALL	LEGE	END					
APPEARANCE	TYPE	DESCRIPTION		UL #	HOURLY RATING	LOCATION	REMARKS
<del>ahhahhahhah</del> .	MASONRY	4" BRICK OR JUMBO E BLOCK BACKING WITH 2"X 4" FURRING @ 16' AND R-17.5 POLY. INSU INTERIOR GYPSUM BO	BRICK WITH 6" CONCRETE I DUROWALL @ 16" O.C. AND O.C. WITH VAPOR BARRIER ULATION COVERED W/ 5/8" ARD.	U902	4HR	ALL EXTERIOR WALLS	CLASS D-2 CMU
	MASONRY		BRICK EACH SIDE WITH 4" . MAINTAIN 5/8" AIR SPACE.	U9O2	4HR	FRONT DECKS	CLASS D-2 CMU
<u></u>	MASONRY	O.C. W/ VAPOR BARRIE	WITH 2"X 2" FURRING @ 16' R & R-15 BATT. INSULATION ERIOR GYPSUM BOARD.	U9O1	4HR	BETWEEN PUB. STAIR & UNIT	CLASS B-4 CMU
<u></u>	FRAME	2"X 4" FRAME INTERI 16" O.C., 1 LAYER OF EACH SIDE. W/ SOUND	OR PARTITION, W/ STUDS @ 1/2" INTERIOR GYP. BD ON D OR THERMAL INSULATION	N/A	N/A	INTERIOR WALLS	
	FRAME	2"X 4" FRAME INTERI 16" O.C., 1 LAYER OF EACH SIDE.	OR PARTITION, W/ STUDS @ 1/2" INTERIOR GYP. BD ON	N/A	N/A	MOST INTERIOR WALLS	
	FRAME	2"X 4" FRAME INTERI 16" O.C., 2 LAYER OF EACH SIDE. WITH SOU	OR PARTITION, W/ STUDS @ 5/8" F.C. GYP. BD ON JND INSULATION.	U3O1	2HR	NOT USED	TYPE C GYP BD
<u></u>	MTL FRAME	ALUMINUM SIDING OVE @ 16" O.C., 4 LAYER C EACH SIDE. WITH R-2	ER 5.5" METAL STUDS DF 1/2" F.C. GYP. BD ON 1 FIBERGLASS BATT. INSUL.	U <b>42</b> 6	3HR	MECH. ACCESS © STAIR TOP ON ROOF	TYPE C GYP BD
······································	MTL FRAME	@ 16" O.C., 2 LAYER C	ER 5.5" METAL STUDS DF 1/2" F.C. GYP. BD ON 1 FIBERGLASS BATT. INSUL.	U419	2HR	INTERIOR DECKS	TYPE C GYP BD
	DOOR	STANDARD WOOD OR	METAL DOOR	N/A	N/A	N/A	REFER TO DOOR SCHEDULE FOR SIZES & TYPES
	WINDOW	STANDARD ALUMINIUM	CLAD WINDOW	N/A	N/A	N/A	REFER TO WINDOW SCHEDULE FOR SIZES & TYPES

1. REFER TO UL BOOK FOR MORE INFORMATION ON THE WALL ASSEMBLIES.


1ARK	DESCRIPTION OF ITEM				
1	CARPENTER BUILT WOOD STAIRS WITH MAXIMUM 8" RISE AND A 10" TREAD INCLUDING 1" NOSING. STAIR TO HAVE A MIN. 36" HIGH HANDRAIL ON ONE SIDE,	6	METAL DECK AND LANDING WITH 42" HIGH IRON GUARD RAILING WITH PICKETS AT 4" O.C. ALL RAILING TO RESIST A 200# HORIZ AND 50# VERTICLE APPLIED FORCE. PROVIDE 4X4 POST @ 60" O.C.	15	10" DIA. ROOF VENT, TYPICAL.
	AS WELL AS A 42" HIGH GUARD RAILING WHEN A STAIR IS OPEN TO AN ADJACENT FLOOR. DETAIL 3/AR3.0 ALL RAILINGS TO RESIST A 200# APPLIED FORCE HORIZ. AND A 50# APPLIED FORCE VERTICALLY. DET: 1/3.1	6A	42" HIGH METAL GUARD RAILING WITH PICKETS @ 4" O.C.	16	4" STEEL COLUMN. SEE FRAMING
	AND A 50# APPLIED FORCE VERTICALLY. DET: 1/3.1	7	MECHANICAL CONDENSERS LOCATED ON CONCRETE PAD	17	4" ALUMN. COPING ATOP MASONRY PARAPET. RAKE & CAULK JOIN
	NON COMBUSTIBLE METAL STAIRS WITH MAXIMUM 8"		OR LEVELING PAD IF LOCATED ON ROOF.	18	BUILT UP CANT STRIP SLOPE TOWARDS SCUPPERS.
2	RISE & A 10" TREAD INCLUDING 1" NOSING. STAIR TO HAVE A MIN. 36" HIGH HANDRAIL ON ONE SIDE, AS WELL AS A 42" HIGH GUARD RAILING AT LANDINGS AND OPEN DECKS. ALL RAILINGS ARE TO BE	8	ELECTRICAL EQUIPMENT CONSISTING OF A MAIN DISCONNECT AND HOUSE PANEL: TO BE WITHIN 5'-O" OF METERS.	19	FLASH AT ROOF AND WALL INTERSECTION.
	CONSTRUCTED TO WITHSTAND A 200# HORIZONTAL LOAD ALONG ANY PORTION OF THE RAILING. DET: C/3.1	9	SUMP PUMP AND EJECTOR, NOTCH OUT FOOTING AS REQUIRED.	20	CLASS "A" RATED SINGLE PLY MODIFIED BITUMEN FLAT ROOFING SYSTEM.
	DECK TO HAVE A FLAT ROOF SYSTEM. PITCH TOWARDS	10	SOUND INSULATION TYPICALLY FOUND AROUND BATHROOMS, FURNACE ROOMS AND LAUNDRY ROOMS	21	5/4" DECKING ATOP WD FLOATERS. FIRE TREATED MATERIAL AND CONFORM TO ASTM-D-83
3	SCUPPER. APPLY 2 X SLEEPERS ATOP FLAT ROOF. WITH COMPOSITE DECKING MATERIAL ABOVE. PROVIDE	11	STORE BOUGHT ACCESS PANEL FOR ACCESS TO JACUZZI PUMP.		
	FLASHING AND BRING FLASHING UP UNDER STONE COPING.  CONCRETE STAIRS TO HAVE A MAXIMUM 8" RISE AND A 10" TREAD. BACK FILL WITH PROPER STONE TO	12	DIRECT VENT GAS FIREPLACE WITH COMBUSTION AIR KIT. NON COMBUSTIBLE HEARTH AS WELL AS A METAL SPARK ARREST AND A BLUE FLAME GAS IGNITOR.		
4	PREVENT ANY FUTURE CRACKS, STAIRS TO HAVE 36" HAND RAIL ON EACH SIDE, ALSO STEPS TO HAVE A LIMESTONE CAP VENEER.	13	ALUMINIUM SCUPPER AND DOWNSPOUT.		
5 AND LITOUR MACONING DARABET WALL WITTH CORTING	14	GUY GREY BOX FOR WASHER AND DRYER, VERIFY W/ PLUMBER.			
5 42" HIGH MASONRY PARAPET WALL WITH COPING.		14A	12" COUNTER TOP OVERHANG		

PATRICK MURPHEY
ACTING ZONING ADMINISTRATOR

APPROVED
Conforms to Zoning Ordinance

RT-4 - ERECT A NEW (3) STORY (4) D.U.


BUILDING W/ BASEMENT, ROOFTOP STAIRWAY ENCLOSURES, OPEN DECKS, SIDE OPEN PORCH, REAR OPEN PORCH, TRASH ENCLOSURE, FENCES, AND A DETACHED (4)

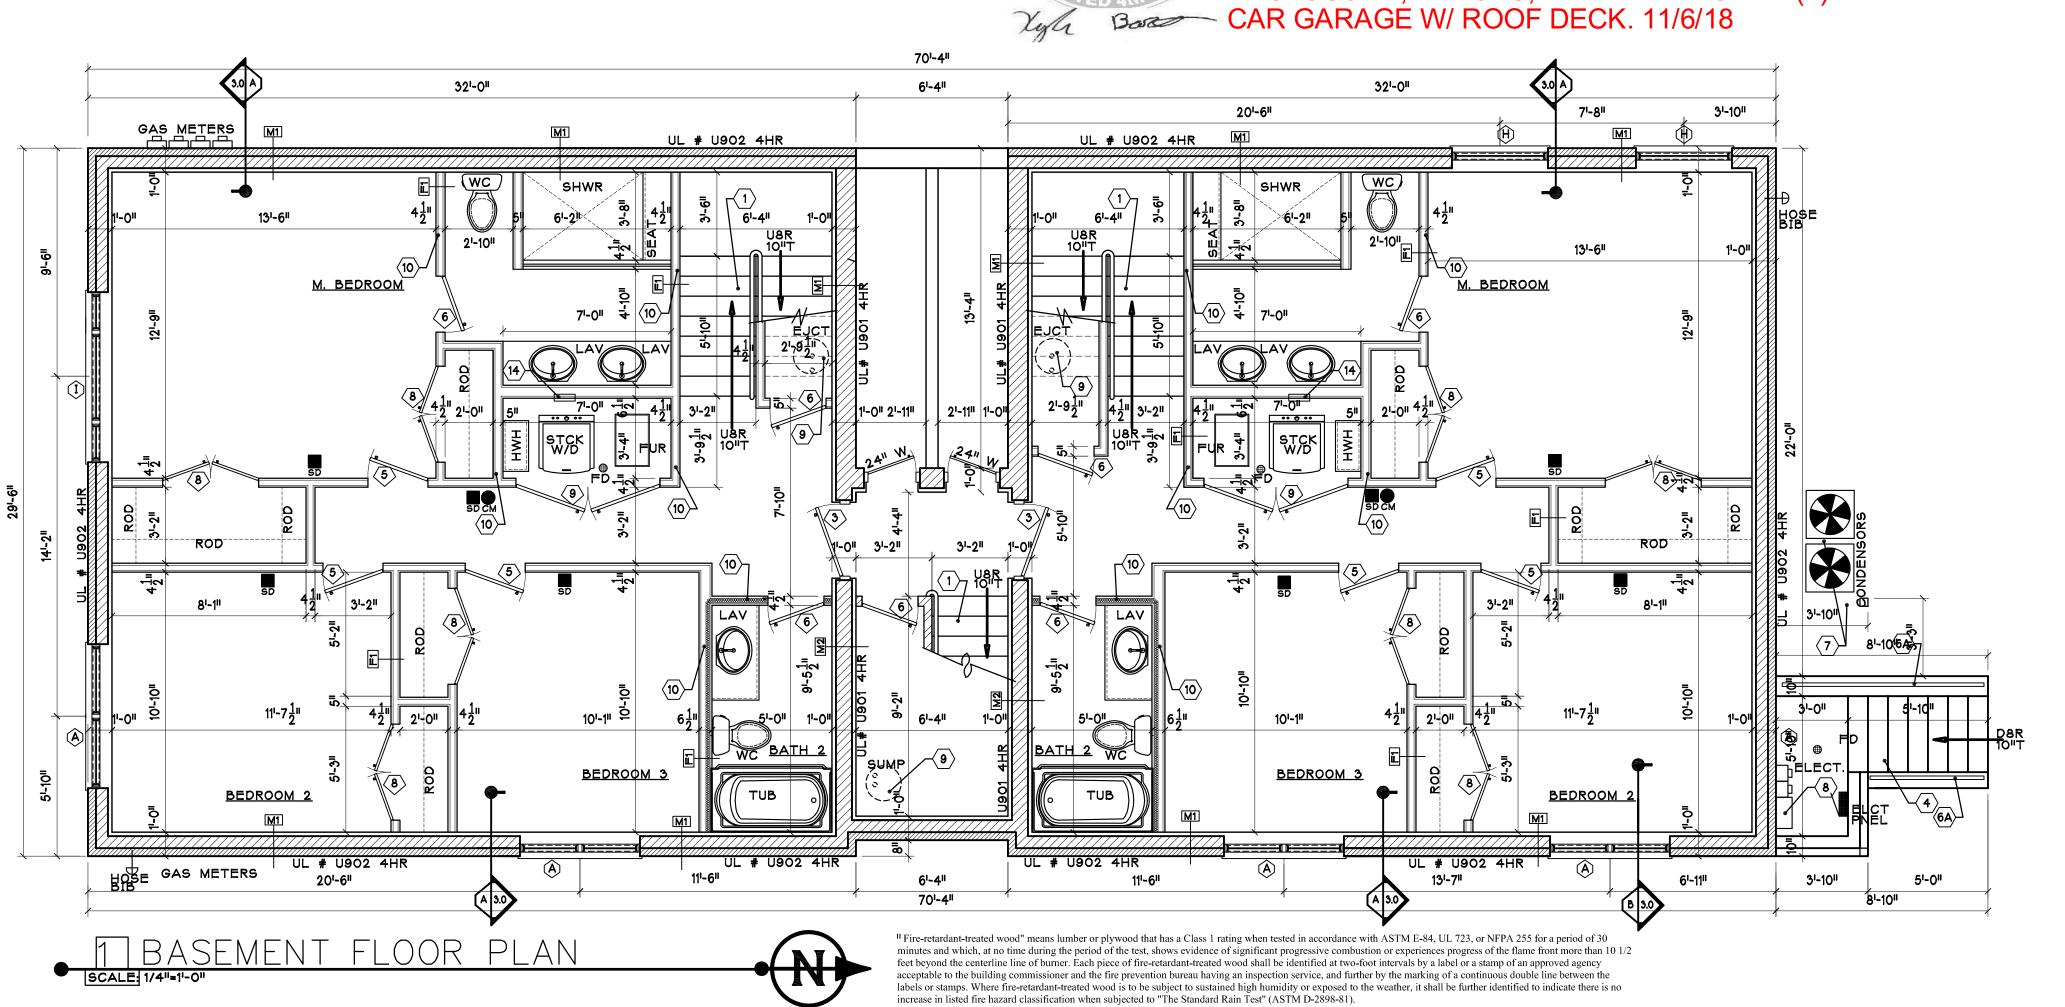

DEPARTMENT OF BUILDINGS STANDARD PLAN REVIEW CONDITIONAL PERMIT

Construction subject to full compliance with the Municipal Code of Chicago and field inspection

By Eder Osty **SELF** CERTIFICATION

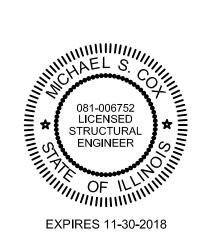

MAC	<sup>9</sup> Accociate	
No.	Revision/Issue	Date
	PERMIT	8/18

MC & Associates, LLC
120 W. MADISON SUITE 310 CHICAGO, IL 60602

PROJECT:
ERECT A NEW MASONRY 4 UNIT BUILDING W/ BASEMENT

PROJECT #:	DRAWING TITLE:
GP	
DATE:	
7/18	DRAWING #:
SCALE:	
AS NOTED	AR-1.0

WALL	LEGE	END					
APPEARANCE	TYPE	DESCRIPTION		UL #	HOURLY RATING	LOCATION	REMARKS
<del>ahhahhahhah</del>	MASONRY	4" BRICK OR JUMBO E BLOCK BACKING WITH 2"X 4" FURRING @ 16' AND R-17.5 POLY. INSI INTERIOR GYPSUM BO	BRICK WITH 6" CONCRETE H DUROWALL @ 16" O.C. AND O.C. WITH VAPOR BARRIER ULATION COVERED W/ 5/8" ARD.	U902	4HR	ALL EXTERIOR WALLS	CLASS D-2 CMU
	MASONRY	4" BRICK OR JUMBO E CONC. BLOCK CENTER	BRICK EACH SIDE WITH 4" . MAINTAIN 5/8" AIR SPACE.	U9O2	4HR	FRONT DECKS	CLASS D-2 CMU
<u> </u>	MASONRY	O.C. W/ VAPOR BARRIE	WITH 2"X 2" FURRING @ 16' R & R-15 BATT. INSULATION ERIOR GYPSUM BOARD.	U9O1	4HR	BETWEEN PUB. STAIR & UNIT	CLASS B-4 CMU
·····	FRAME	2"X 4" FRAME INTERI 16" O.C., 1 LAYER OF EACH SIDE. W/ SOUNI	OR PARTITION, W/ STUDS @ 1/2" INTERIOR GYP. BD ON D OR THERMAL INSULATION	N/A	N/A	INTERIOR WALLS	
====	FRAME	2"X 4" FRAME INTERI 16" O.C., 1 LAYER OF EACH SIDE.	OR PARTITION, W/ STUDS @ 1/2" INTERIOR GYP. BD ON	N/A	N/A	MOST INTERIOR WALLS	
	FRAME	2"X 4" FRAME INTERI 16" O.C., 2 LAYER OF EACH SIDE. WITH SOU	OR PARTITION, W/ STUDS @ 5/8" F.C. GYP. BD ON JND INSULATION.	U3O1	2HR	NOT USED	TYPE C GYP BD
<u></u>	MTL FRAME	@ 16" O.C 4 LAYER C	ER 5.5" METAL STUDS OF 1/2" F.C. GYP. BD ON 1 FIBERGLASS BATT. INSUL.	U426	3HR	MECH. ACCESS © STAIR TOP ON ROOF	TYPE C GYP BD
<u></u>	MTL FRAME	@ 16" O.C., 2 LAYER C	ER 5.5" METAL STUDS OF 1/2" F.C. GYP. BD ON 1 FIBERGLASS BATT. INSUL.	U419	2HR	INTERIOR DECKS	TYPE C GYP BD
	DOOR	STANDARD WOOD OR	METAL DOOR	N/A	N/A	N/A	REFER TO DOOR SCHEDULE FOR SIZES & TYPES
	WINDOW	STANDARD ALUMINIUM	CLAD WINDOW	N/A	N/A	N/A	REFER TO WINDOW SCHEDULE FOR SIZES & TYPES


1. REFER TO UL BOOK FOR MORE INFORMATION ON THE WALL ASSEMBLIES.

TAGGED	NOTES	

MARK	DESCRIPTION OF ITEM				
1	CARPENTER BUILT <u>WOOD</u> STAIRS WITH MAXIMUM 8" RISE AND A 10" TREAD INCLUDING 1" NOSING. STAIR TO HAVE A MIN. 36" HIGH HANDRAIL ON ONE SIDE,	6	METAL DECK AND LANDING WITH 42" HIGH IRON GUARD RAILING WITH PICKETS AT 4" O.C. ALL RAILING TO RESIST A 200# HORIZ AND 50# VERTICLE APPLIED FORCE. PROVIDE 4X4 POST @ 60" O.C.	15	10" DIA. ROOF VENT, TYPICAL.
	AS WELL AS A 42" HIGH GUARD RAILING WHEN A STAIR IS OPEN TO AN ADJACENT FLOOR. DETAIL 3/AR3.0 ALL RAILINGS TO RESIST A 200# APPLIED FORCE HORIZ. AND A 50# APPLIED FORCE VERTICALLY. DET: 1/3.1	6A	42" HIGH METAL GUARD RAILING WITH PICKETS @ 4" O.C.	16	4" STEEL COLUMN. SEE FRAMING
	AND A 50# APPLIED FORCE VERTICALLY. DET: 1/3.1		MECHANICAL CONDENSERS LOCATED ON CONCRETE PAD	17	4" ALUMN. COPING ATOP MASONRY PARAPET. RAKE & CAULK JOINTS
	NON COMBUSTIBLE <u>METAL</u> STAIRS WITH MAXIMUM 8" RISE & A 10" TREAD INCLUDING 1" NOSING. STAIR TO		OR LEVELING PAD IF LOCATED ON ROOF.	18	BUILT UP CANT STRIP SLOPE TOWARDS SCUPPERS.
2	HAVE A MIN. 36" HIGH HANDRAIL ON ONE SIDE, AS WELL AS A 42" HIGH GUARD RAILING AT ANDINGS AND OPEN DECKS, ALL RAILINGS ARE TO BE	8	ELECTRICAL EQUIPMENT CONSISTING OF A MAIN DISCONNECT AND HOUSE PANEL: TO BE WITHIN 5'-O" OF METERS.	19	FLASH AT ROOF AND WALL INTERSECTION.
	CONSTRUCTED TO WITHSTAND A 200# HORIZONTAL LOAD ALONG ANY PORTION OF THE RAILING. DET: C/3.1	9	SUMP PUMP AND EJECTOR, NOTCH OUT FOOTING AS REQUIRED.	20	CLASS "A" RATED SINGLE PLY MODIFIED BITUMEN FLAT ROOFING SYSTEM.
_	DECK TO HAVE A FLAT ROOF SYSTEM. PITCH TOWARDS	10	SOUND INSULATION TYPICALLY FOUND AROUND BATHROOMS, FURNACE ROOMS AND LAUNDRY ROOMS	21	5/4" DECKING ATOP WD FLOATERS. FIRE TREATED MATERIAL AND CONFORM TO ASTM-D-83
3	SCUPPER. APPLY 2 X SLEEPERS ATOP FLAT ROOF. WITH COMPOSITE DECKING MATERIAL ABOVE. PROVIDE	11	STORE BOUGHT ACCESS PANEL FOR ACCESS TO JACUZZI PUMP.		
	FLASHING AND BRING FLASHING UP UNDER STONE COPING.	10	DIRECT VENT GAS FIREPLACE WITH COMBUSTION		
	CONCRETE STAIRS TO HAVE A MAXIMUM 8" RISE AND A 10" TREAD. BACK FILL WITH PROPER STONE TO PREVENT ANY FUTURE CRACKS. STAIRS TO HAVE 36" HAND RAIL ON EACH SIDE. ALSO STEPS TO HAVE A LIMESTONE CAP VENEER.		AIR KIT. NON COMBUSTIBLE HEARTH AS WELL AS A METAL SPARK ARREST AND A BLUE FLAME GAS IGNITOR.		
4			ALUMINIUM SCUPPER AND DOWNSPOUT.		
5	40" LITOU MACONEY DARABET WALL WITH CORING	14	GUY GREY BOX FOR WASHER AND DRYER, VERIFY W/ PLUMBER.		
	42" HIGH MASONRY PARAPET WALL WITH COPING.	14A	12" COUNTER TOP OVERHANG		

PATRICK MURPHEY ACTING ZONING ADMINISTRATOR

DEPARTMENT OF PLANNING RT-4 - ERECT A NEW (3) STORY (4) D.U. APPROVED BUILDING W/ BASEMÈNT, ROOFTÓP STAIRWAY ENCLOSURES, OPEN DECKS, SIDE OPEN PORCH, REAR OPEN PORCH, TRASH ENCLOSURE, FENCES, AND A DETACHED (4)

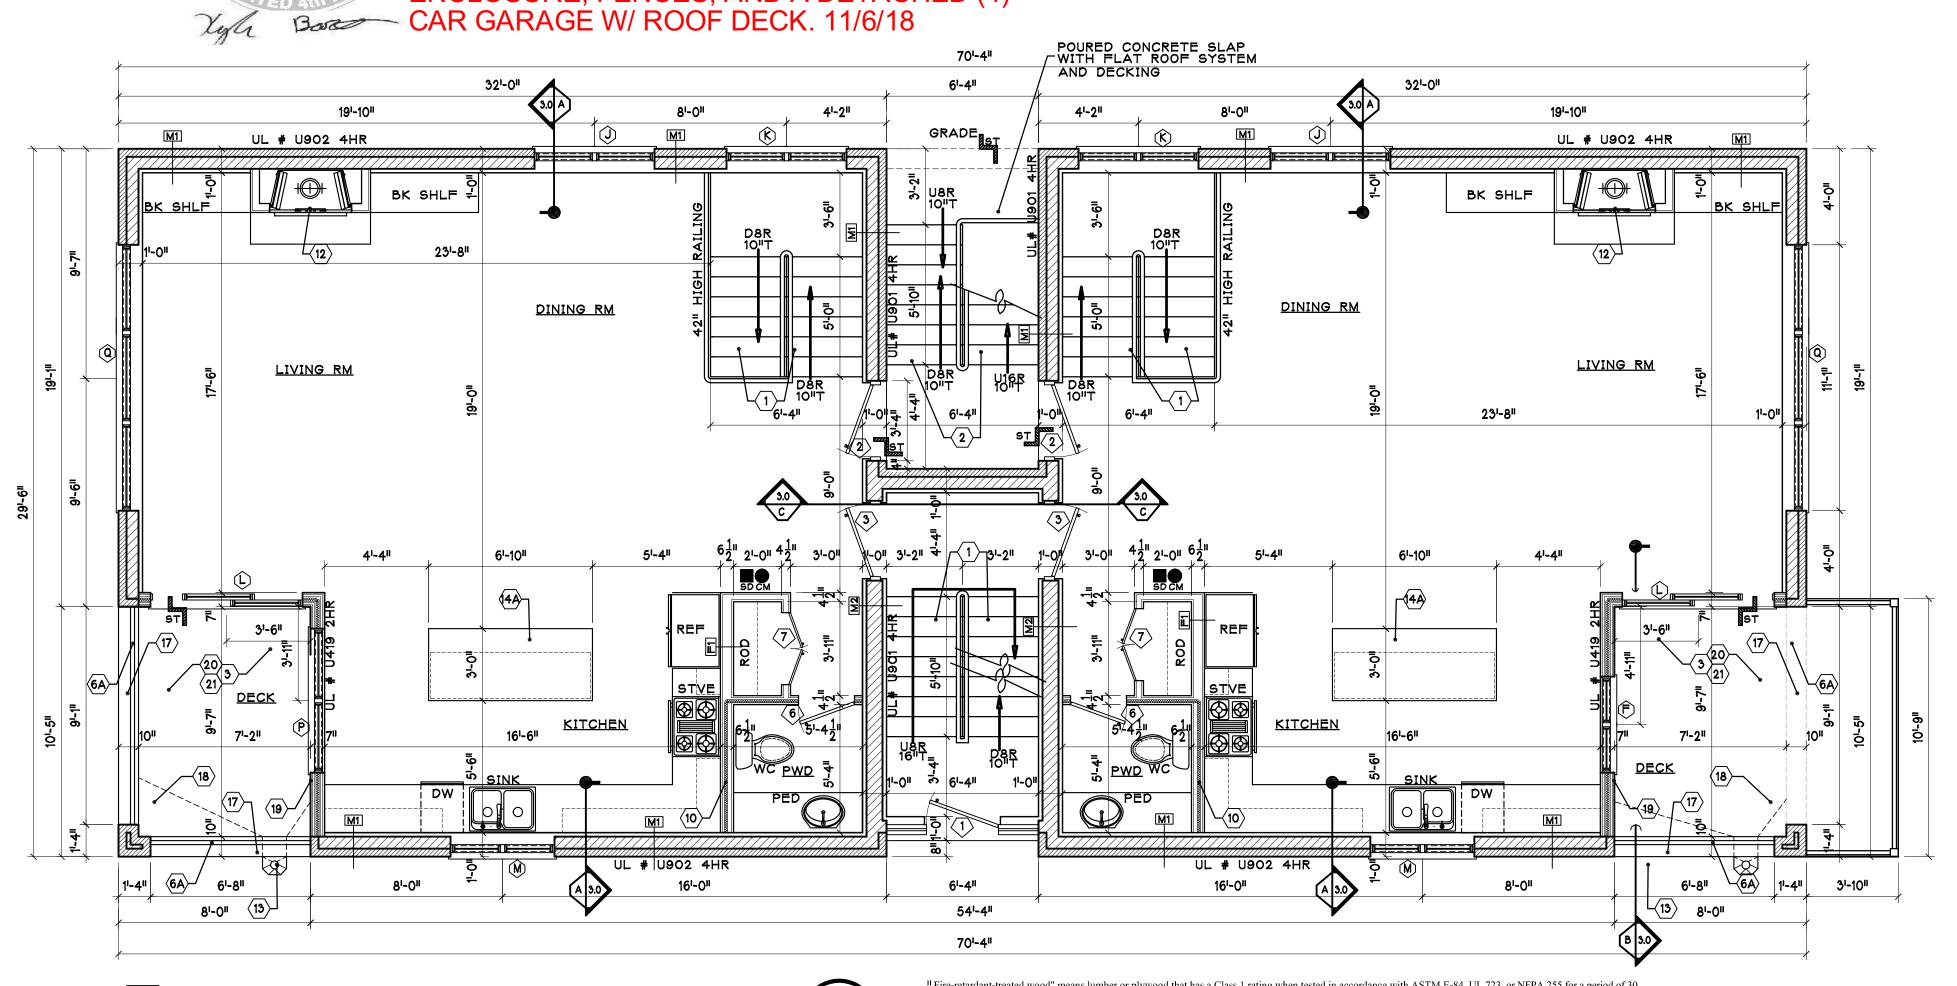


<sup>11</sup> Fire-retardant-treated wood" means lumber or plywood that has a Class 1 rating when tested in accordance with ASTM E-84, UL 723, or NFPA 255 for a period of 30 minutes and which, at no time during the period of the test, shows evidence of significant progressive combustion or experiences progress of the flame front more than 10 1/2 feet beyond the centerline line of burner. Each piece of fire-retardant-treated wood shall be identified at two-foot intervals by a label or a stamp of an approved agency acceptable to the building commissioner and the fire prevention bureau having an inspection service, and further by the marking of a continuous double line between the labels or stamps. Where fire-retardant-treated wood is to be subject to sustained high humidity or exposed to the weather, it shall be further identified to indicate there is no increase in listed fire hazard classification when subjected to "The Standard Rain Test" (ASTM D-2898-81).

DEPARTMENT OF BUILDINGS STANDARD PLAN REVIEW CONDITIONAL PERMIT

Construction subject to full compliance with the Municipal Code of Chicago and field inspection By Eder P Cally

SELF CERTIFICATION

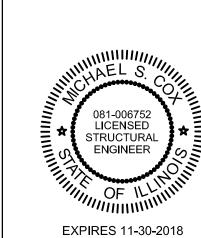

	PERMIT	8/18
No.	Revision/Issue	Date
		•

MC & Associates,

120 W. MADISON SUITE 310 CHICAGO, IL 60602

PROJECT:

AS NOTED

ERECT A NEW MASONRY 4 UNIT BUILDING W/ BASEMENT

PROJECT #: DRAWING TITLE: DATE: 7/18 DRAWING #: SCALE: AR-1.

WALL	LEGE	END					
APPEARANCE	TYPE	DESCRIPTION		UL #	HOURLY RATING	LOCATION	REMARKS
<del>addaddaddadda</del>	MASONRY	4" BRICK OR JUMBO E BLOCK BACKING WITH 2"X 4" FURRING @ 16' AND R-17.5 POLY. INSU INTERIOR GYPSUM BO	BRICK WITH 6" CONCRETE H DUROWALL @ 16" O.C. AND O.C. WITH VAPOR BARRIER JLATION COVERED W/ 5/8" ARD.	U902	4HR	ALL EXTERIOR WALLS	CLASS D-2 CMU
	MASONRY		BRICK EACH SIDE WITH 4" . MAINTAIN 5/8" AIR SPACE.	U902	4HR	FRONT DECKS	CLASS D-2 CMU
<u> </u>	MASONRY	O.C. W/ VAPOR BARRIE	WITH 2"X 2" FURRING @ 16' R & R-15 BATT. INSULATION ERIOR GYPSUM BOARD.	U901	4HR	BETWEEN PUB. STAIR & UNIT	CLASS B-4 CMU
	FRAME	2"X 4" FRAME INTERI 16" O.C., 1 LAYER OF EACH SIDE. W/ SOUND	OR PARTITION, W/ STUDS @ 1/2" INTERIOR GYP. BD ON OR THERMAL INSULATION	N/A	N/A	INTERIOR WALLS	
	FRAME	2"X 4" FRAME INTERI 16" O.C., 1 LAYER OF EACH SIDE.	OR PARTITION, W/ STUDS @ 1/2" INTERIOR GYP. BD ON	N/A	N/A	MOST INTERIOR WALLS	
<u>:[:::::::::::::::::::::::::::::::::::</u>	FRAME	2"X 4" FRAME INTERI 16" O.C., 2 LAYER OF EACH SIDE. WITH SOU	OR PARTITION, W/ STUDS @ 5/8" F.C. GYP. BD ON JND INSULATION.	U3O1	2HR	NOT USED	TYPE C GYP BD
······································	MTL FRAME	ALUMINUM SIDING OVE @ 16" O.C., 4 LAYER C EACH SIDE. WITH R-2	ER 5.5" METAL STUDS OF 1/2" F.C. GYP. BD ON 1 FIBERGLASS BATT. INSUL.	U <b>42</b> 6	3HR	MECH. ACCESS © STAIR TOP ON ROOF	TYPE C GYP BD
<u></u>	MTL FRAME	ALUMINUM SIDING OVE @ 16" O.C., 2 LAYER O EACH SIDE. WITH R-2	ER 5.5" METAL STUDS OF 1/2" F.C. GYP. BD ON 1 FIBERGLASS BATT. INSUL.	U419	2HR	INTERIOR DECKS	TYPE C GYP BD
	DOOR	STANDARD WOOD OR	METAL DOOR	N/A	N/A	N/A	REFER TO DOOR SCHEDULE FOR SIZES & TYPES
	WINDOW	STANDARD ALUMINIUM	CLAD WINDOW	N/A	N/A	N/A	REFER TO WINDOW SCHEDULE FOR SIZES & TYPES


NOTES:


1. REFER TO UL BOOK FOR MORE INFORMATION ON THE WALL ASSEMBLIES.

T/	AGGED NOTES				
MARK	DESCRIPTION OF ITEM				
1	CARPENTER BUILT <u>WOOD</u> STAIRS WITH MAXIMUM 8" RISE AND A 10" TREAD INCLUDING 1" NOSING. STAIR TO HAVE A MIN. 36" HIGH HANDRAIL ON ONE SIDE,	6	METAL DECK AND LANDING WITH 42" HIGH IRON GUARD RAILING WITH PICKETS AT 4" O.C. ALL RAILING TO RESIST A 200# HORIZ AND 50# VERTICLE APPLIED FORCE. PROVIDE 4X4 POST @ 60" O.C.	15	10" DIA. ROOF VENT, TYPICAL.
	AS WELL AS A 42" HIGH GUARD RAILING WHEN A STAIR IS OPEN TO AN ADJACENT FLOOR. DETAIL 3/AR3.0 ALL RAILINGS TO RESIST A 200# APPLIED FORCE HORIZ.	6A	42" HIGH METAL GUARD RAILING WITH PICKETS @ 4" O.C.	16	4" STEEL COLUMN. SEE FRAMING
	ALL RAILINGS TO RESIST A 200# APPLIED FORCE HORIZ.  AND A 50# APPLIED FORCE VERTICALLY. DET: 1/3.1	7	MECHANICAL CONDENSERS LOCATED ON CONCRETE PAD	17	4" ALUMN. COPING ATOP MASONRY PARAPET. RAKE & CAULK JOINT
	NON COMBUSTIBLE <u>METAL</u> STAIRS WITH MAXIMUM 8" RISE & A 10" TREAD INCLUDING 1" NOSING. STAIR TO		OR LEVELING PAD IF LOCATED ON ROOF.	18	BUILT UP CANT STRIP SLOPE TOWARDS SCUPPERS.
2	HAVE A MIN. 36" HIGH HANDRAIL ON ONE SIDE, AS WELL AS A 42" HIGH GUARD RAILING AT LANDINGS AND OPEN DECKS, ALL RAILINGS ARE TO BE	8	ELECTRICAL EQUIPMENT CONSISTING OF A MAIN DISCONNECT AND HOUSE PANEL: TO BE WITHIN 5'-O" OF METERS.	19	FLASH AT ROOF AND WALL INTERSECTION.
	CONSTRUCTED TO WITHSTAND A 200# HORIZONTAL LOAD ALONG ANY PORTION OF THE RAILING. DET: C/3.1	9	SUMP PUMP AND EJECTOR, NOTCH OUT FOOTING AS REQUIRED.	20	CLASS "A" RATED SINGLE PLY MODIFIED BITUMEN FLAT ROOFING SYSTEM.
	DECK TO HAVE A FLAT ROOF SYSTEM. PITCH TOWARDS	10	SOUND INSULATION TYPICALLY FOUND AROUND BATHROOMS, FURNACE ROOMS AND LAUNDRY ROOMS	21	5/4" DECKING ATOP WD FLOATERS. FIRE TREATED MATERIAL AND CONFORM TO ASTM-D-83
3	SCUPPER. APPLY 2 X SLEEPERS ATOP FLAT ROOF. WITH COMPOSITE DECKING MATERIAL ABOVE. PROVIDE	11	STORE BOUGHT ACCESS PANEL FOR ACCESS TO JACUZZI PUMP.		
	FLASHING AND BRING FLASHING UP UNDER STONE COPING.  CONCRETE STAIRS TO HAVE A MAXIMUM 8" RISE AND A 10" TREAD. BACK FILL WITH PROPER STONE TO	12	DIRECT VENT GAS FIREPLACE WITH COMBUSTION AIR KIT. NON COMBUSTIBLE HEARTH AS WELL AS A METAL SPARK ARREST AND A BLUE FLAME GAS IGNITOR.		
4	PREVENT ANY FUTURE CRACKS. STAIRS TO HAVE 36" HAND RAIL ON EACH SIDE. ALSO STEPS TO HAVE A LIMESTONE CAP VENEER.	13	ALUMINIUM SCUPPER AND DOWNSPOUT.		
5	40" LITCLE MACONEY BARABET WALL WITH CORNE	14	GUY GREY BOX FOR WASHER AND DRYER, VERIFY W/ PLUMBER.		
<b>J</b>	42" HIGH MASONRY PARAPET WALL WITH COPING.	14A	12" COUNTER TOP OVERHANG		

DEPARTMENT OF PLANNING
AND DEVELOPMENT
APPROVED
Conforms to Zoning Ordinance
PATRICK MURPHEY
ACTING ZONING ADMINISTRATOR

RT-4 - ERECT A NEW (3) STORY (4) D.U. BUILDING W/ BASEMENT, ROOFTOP STAIRWAY ENCLOSURES, OPEN DECKS, SIDE OPEN PORCH, REAR OPEN PORCH, TRASH ENCLOSURE, FENCES, AND A DETACHED (4)

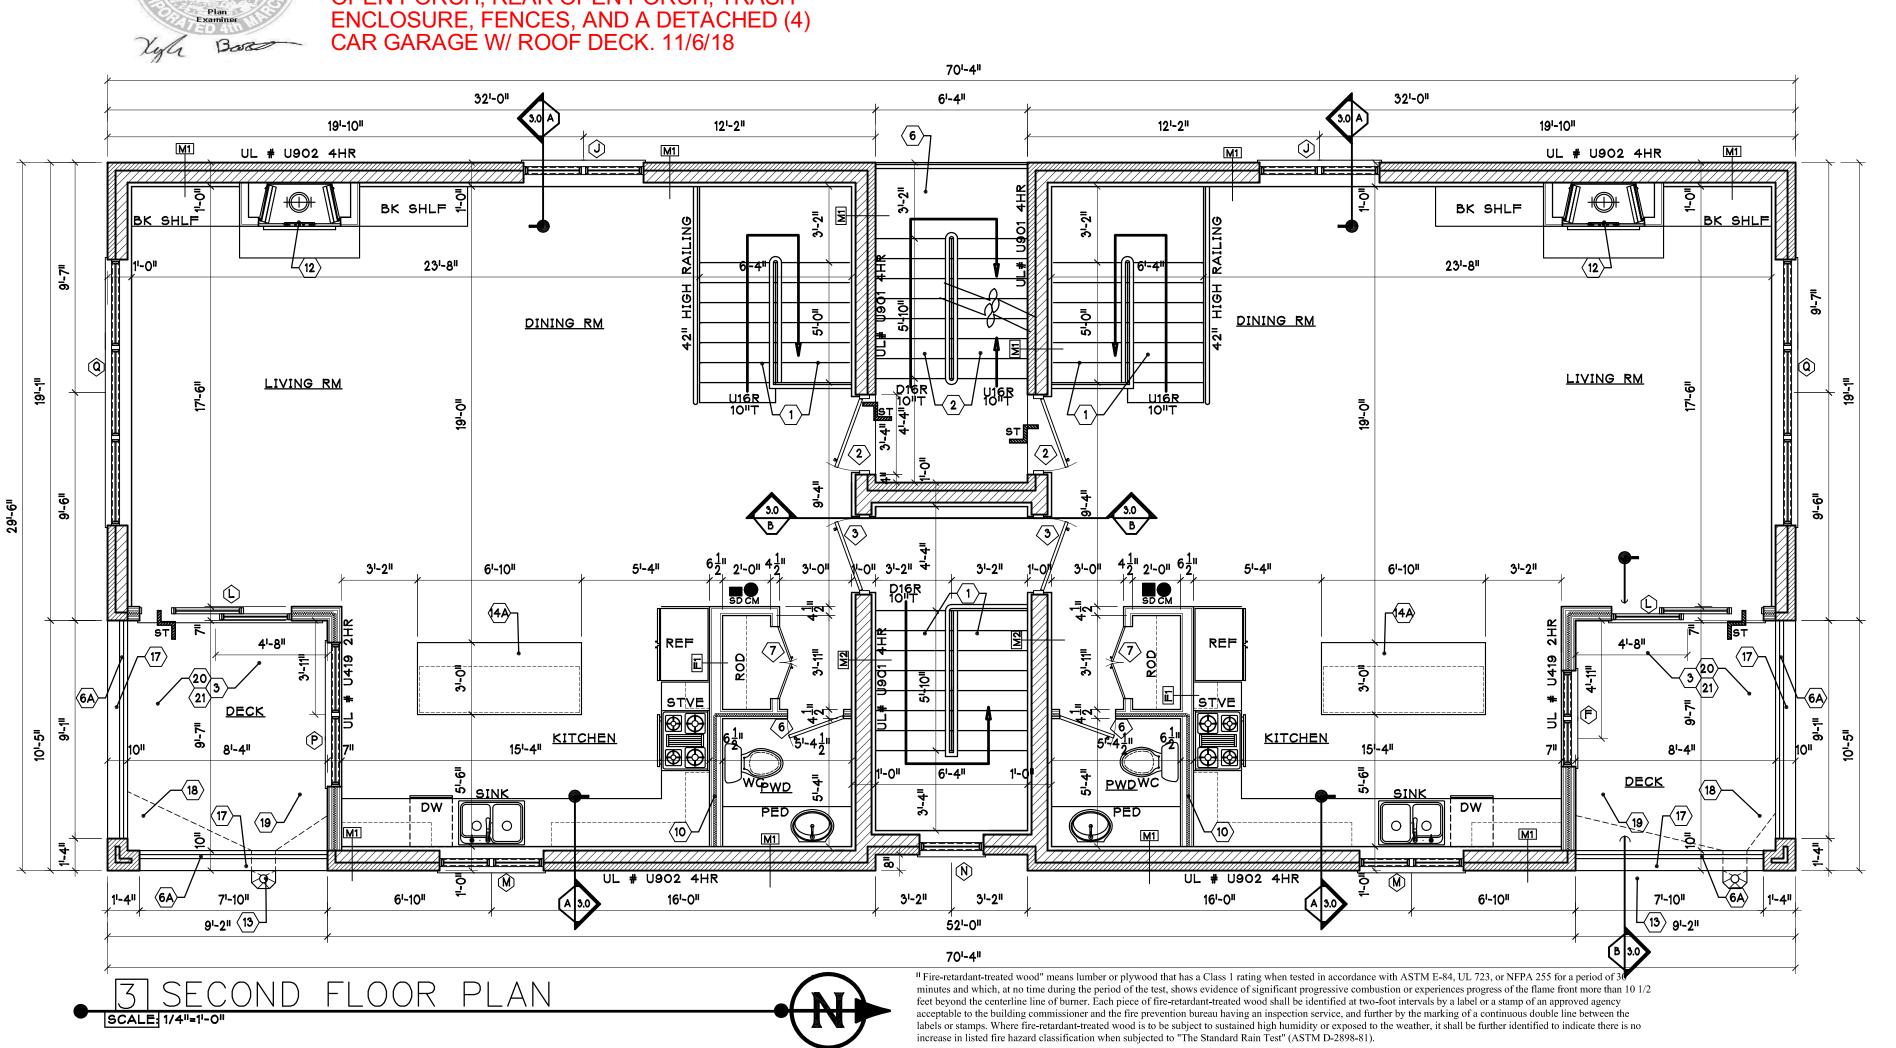

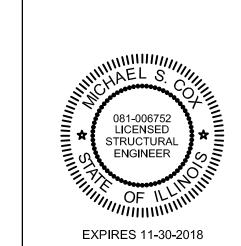

STANDARD PLAN REVIEW
CONDITIONAL

PERMIT

Construction subject to full compliance with the Municipal Code of Chicago and field inspection

SELF CERTIFICATION

By Edert Oakty

	PERMIT	8/18
No.	Revision/Issue	Date

MC & Associates,

120 W. MADISON SUITE 310 CHICAGO, IL 60602

PROJECT:

ERECT A NEW MASONRY 4 UNIT BUILDING W/ BASEMENT

PROJECT #: DRAWING TITLE:

GP

DATE:

7/18 DRAWING #:

SCALE:
AS NOTED

ARAMING #:

ARAMING #:

ARAMING #:

WALL	LEGE	END					
APPEARANCE	TYPE	DESCRIPTION		UL #	HOURLY RATING	LOCATION	REMARKS
<del>anhadanaha.</del>	MASONRY	4" BRICK OR JUMBO B BLOCK BACKING WITH 2"X 4" FURRING @ 16' AND R-17.5 POLY. INSI INTERIOR GYPSUM BO	BRICK WITH 6" CONCRETE H DUROWALL @ 16" O.C. AND O.C. WITH VAPOR BARRIER JLATION COVERED W/ 5/8" ARD.	U902	4HR	ALL EXTERIOR WALLS	CLASS D-2 CMU
	MASONRY	4" BRICK OR JUMBO E CONC. BLOCK CENTER	BRICK EACH SIDE WITH 4" . MAINTAIN 5/8" AIR SPACE.	U902	4HR	FRONT DECKS	CLASS D-2 CMU
<u> </u>	MASONRY	O.C. W/ VAPOR BARRIE	WITH 2"X 2" FURRING @ 16' R & R-15 BATT. INSULATION ERIOR GYPSUM BOARD.	U901	4HR	BETWEEN PUB. STAIR & UNIT	CLASS B-4 CMU
	FRAME	2"X 4" FRAME INTERI 16" O.C., 1 LAYER OF EACH SIDE. W/ SOUNT	OR PARTITION, W/ STUDS @ 1/2" INTERIOR GYP. BD ON O OR THERMAL INSULATION	N/A	N/A	INTERIOR WALLS	
	FRAME	2"X 4" FRAME INTERI 16" O.C., 1 LAYER OF EACH SIDE.	OR PARTITION, W/ STUDS @ 1/2" INTERIOR GYP. BD ON	N/A	N/A	MOST INTERIOR WALLS	
	FRAME	2"X 4" FRAME INTERI 16" O.C., 2 LAYER OF EACH SIDE. WITH SOU	OR PARTITION, W/ STUDS @ 5/8" F.C. GYP. BD ON JND INSULATION.	U3O1	2HR	NOT USED	TYPE C GYP BD
<u></u>	MTL FRAME	ALUMINUM SIDING OVE @ 16" O.C., 4 LAYER C EACH SIDE. WITH R-2	ER 5.5" METAL STUDS DF 1/2" F.C. GYP. BD ON 1 FIBERGLASS BATT. INSUL.	U <b>42</b> 6	3HR	MECH. ACCESS © STAIR TOP ON ROOF	TYPE C GYP BD
<u></u>	MTL FRAME	ALUMINUM SIDING OVE @ 16" O.C., 2 LAYER C EACH SIDE. WITH R-2	ER 5.5" METAL STUDS OF 1/2" F.C. GYP. BD ON 1 FIBERGLASS BATT. INSUL.	U419	2HR	INTERIOR DECKS	TYPE C GYP BD
	DOOR	STANDARD WOOD OR	METAL DOOR	N/A	N/A	N/A	REFER TO DOOR SCHEDULE FOR SIZES & TYPES
	WINDOW	STANDARD ALUMINIUM	CLAD WINDOW	N/A	N/A	N/A	REFER TO WINDOW SCHEDULE FOR SIZES & TYPES

1. REFER TO UL BOOK FOR MORE INFORMATION ON THE WALL ASSEMBLIES.

$\top$	AGGED NOTES				
MARK	DESCRIPTION OF ITEM				
1	CARPENTER BUILT <u>WOOD</u> STAIRS WITH MAXIMUM 8" RISE AND A 10" TREAD INCLUDING 1" NOSING. STAIR TO HAVE A MIN. 36" HIGH HANDRAIL ON ONE SIDE,	6	METAL DECK AND LANDING WITH 42" HIGH IRON GUARD RAILING WITH PICKETS AT 4" O.C. ALL RAILING TO RESIST A 200# HORIZ AND 50# VERTICLE APPLIED FORCE. PROVIDE 4X4 POST @ 60" O.C.	15	10" DIA. ROOF VENT, TYPICAL.
	HAVE A MIN. 36" HIGH HANDRAIL ON ONE SIDE, AS WELL AS A 42" HIGH GUARD RAILING WHEN A STAIR IS OPEN TO AN ADJACENT FLOOR, DETAIL 3/AR3.0	6A	42" HIGH METAL GUARD RAILING WITH PICKETS @ 4" O.C.	16	4" STEEL COLUMN. SEE FRAMING
	ALL RAILINGS TO RESIST A 200# APPLIED FORCE HORIZ. AND A 50# APPLIED FORCE VERTICALLY. DET: 1/3.1	7	MECHANICAL CONDENSERS LOCATED ON CONCRETE PAD	17	4" ALUMN. COPING ATOP MASONRY PARAPET. RAKE & CAULK JOINTS
	NON COMBUSTIBLE METAL STAIRS WITH MAXIMUM 8" RISE & A 10" TREAD INCLUDING 1" NOSING. STAIR TO HAVE A MIN. 36" HIGH HANDRAIL ON ONE SIDE, AS WELL AS A 42" HIGH GUARD RAILING AT LANDINGS AND OPEN DECKS. ALL RAILINGS ARE TO BE		OR LEVELING PAD IF LOCATED ON ROOF.	18	BUILT UP CANT STRIP SLOPE TOWARDS SCUPPERS.
2		8	ELECTRICAL EQUIPMENT CONSISTING OF A MAIN DISCONNECT AND HOUSE PANEL: TO BE WITHIN 5'-O" OF METERS.	19	FLASH AT ROOF AND WALL INTERSECTION.
	CONSTRUCTED TO WITHSTAND A 200# HORIZONTAL LOAD ALONG ANY PORTION OF THE RAILING. DET: C/3.1	9	SUMP PUMP AND EJECTOR, NOTCH OUT FOOTING AS REQUIRED.	20	CLASS "A" RATED SINGLE PLY MODIFIED BITUMEN FLAT ROOFING SYSTEM.
	DECK TO HAVE A FLAT ROOF SYSTEM. PITCH TOWARDS	10	SOUND INSULATION TYPICALLY FOUND AROUND BATHROOMS, FURNACE ROOMS AND LAUNDRY ROOMS	21	5/4" DECKING ATOP WD FLOATERS. FIRE TREATED MATERIAL AND CONFORM TO ASTM-D-83
3	SCUPPER. APPLY 2 X SLEEPERS ATOP FLAT ROOF. WITH COMPOSITE DECKING MATERIAL ABOVE. PROVIDE	11	STORE BOUGHT ACCESS PANEL FOR ACCESS TO JACUZZI PUMP.		
	FLASHING AND BRING FLASHING UP UNDER STONE COPING.	12	DIRECT VENT GAS FIREPLACE WITH COMBUSTION		
	CONCRETE STAIRS TO HAVE A MAXIMUM 8" RISE AND A 10" TREAD, BACK FILL WITH PROPER STONE TO		AIR KIT. NON COMBUSTIBLE HEARTH AS WELL AS A METAL SPARK ARREST AND A BLUE FLAME GAS IGNITOR.		
4	PREVENT ANY FUTURE CRACKS. STAIRS TO HAVE 36" HAND RAIL ON EACH SIDE. ALSO STEPS TO HAVE A LIMESTONE CAP VENEER.		ALUMINIUM SCUPPER AND DOWNSPOUT.		
5	42" HIGH MASONRY PARAPET WALL WITH COPING.	14	GUY GREY BOX FOR WASHER AND DRYER, VERIFY W/ PLUMBER.		
	TZ THOT WASONIN PANAFET WALL WITH COPING.	1 <del>4</del> A	12" COUNTER TOP OVERHANG		


APPROVED


Genforms to Zoning Ordinance

RT-4 - ERECT A NEW (3) STORY (4) D.U.

BUILDING W/ BASEMENT, ROOFTOP STAIRWAY ENCLOSURES, OPEN DECKS, SIDE OPEN PORCH, REAR OPEN PORCH, TRASH ENCLOSURE, FENCES, AND A DETACHED (4)

CAR GARAGE W/ ROOF DECK. 11/6/18

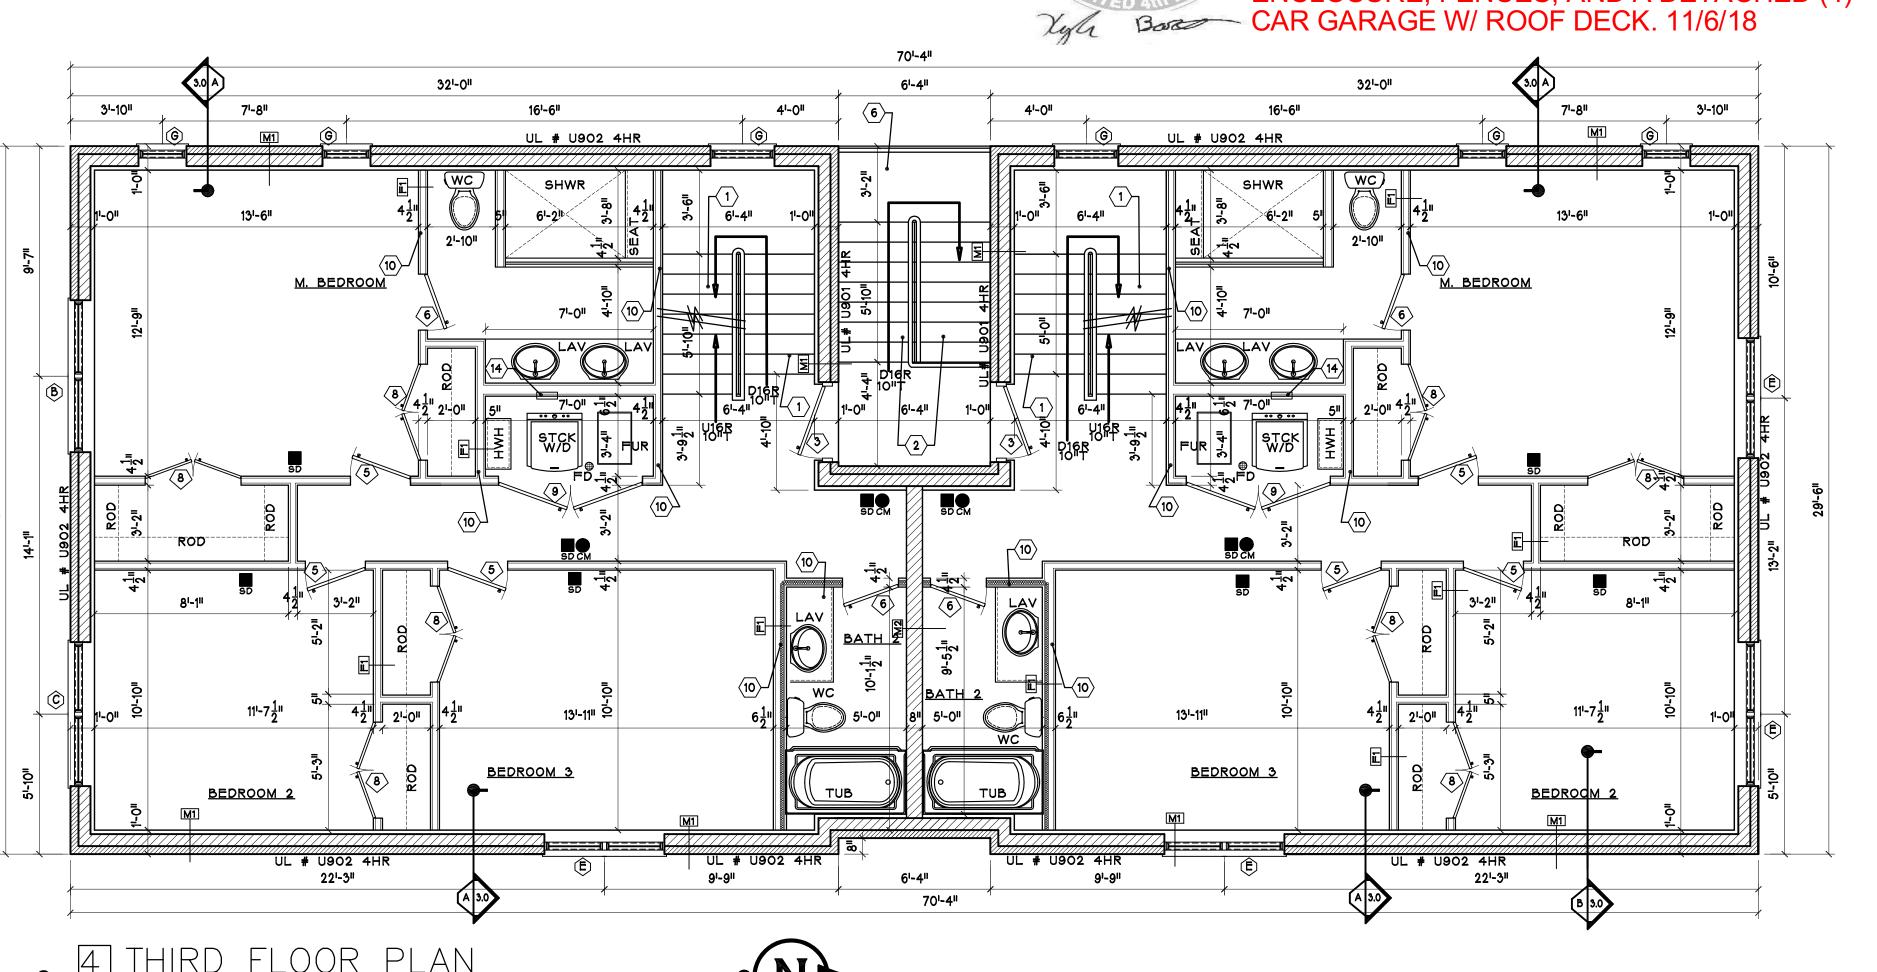

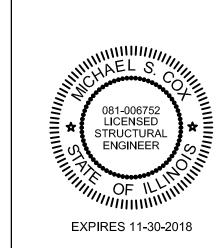

DEPARTMENT OF BUILDINGS STANDARD PLAN REVIEW CONDITIONAL

PERMIT

Construction subject to full compliance with the Municipal Code of Chicago and field inspection

By Edut Cath

SELF CERTIFICATION

	PERMIT	8/18
No.	Revision/Issue	Date

MC & Associates, LLC

120 W. MADISON SUITE 310 CHICAGO, IL 60602

PROJECT:


ERECT A NEW MASONRY 4 UNIT BUILDING W/ BASEMENT


DRAWING TITLE: PROJECT #: DRAWING #: |AR - 1.3|AS NOTED

WALL	LEGE	END					
APPEARANCE	TYPE	DESCRIPTION		UL #	HOURLY RATING	LOCATION	REMARKS
<del>anthuthuthuth</del> .	MASONRY	4" BRICK OR JUMBO B BLOCK BACKING WITH 2"X 4" FURRING @ 16' AND R-17.5 POLY. INSI INTERIOR GYPSUM BO	BRICK WITH 6" CONCRETE I DUROWALL @ 16" O.C. AND O.C. WITH VAPOR BARRIER ULATION COVERED W/ 5/8" ARD.	U902	4HR	ALL EXTERIOR WALLS	CLASS D-2 CMU
	MASONRY	4" BRICK OR JUMBO E CONC. BLOCK CENTER	BRICK EACH SIDE WITH 4" R. MAINTAIN 5/8" AIR SPACE.	U902	4HR	FRONT DECKS	CLASS D-2 CMU
<u>//////</u>	MASONRY	O.C. W/ VAPOR BARRIE	WITH 2"X 2" FURRING @ 16' R & R-15 BATT. INSULATION ERIOR GYPSUM BOARD.	U901	4HR	BETWEEN PUB. STAIR & UNIT	CLASS B-4 CMU
<u></u>	FRAME	2"X 4" FRAME INTERI 16" O.C., 1 LAYER OF EACH SIDE. W/ SOUND	OR PARTITION, W/ STUDS @ 1/2" INTERIOR GYP. BD ON D OR THERMAL INSULATION	N/A	N/A	INTERIOR WALLS	
	FRAME	2"X 4" FRAME INTERI 16" O.C., 1 LAYER OF EACH SIDE.	OR PARTITION, W/ STUDS @ 1/2" INTERIOR GYP. BD ON	N/A	N/A	MOST INTERIOR WALLS	
<u>:[:::::::::::::::::::::::::::::::::::</u>	FRAME	2"X 4" FRAME INTERI 16" O.C., 2 LAYER OF EACH SIDE. WITH SOU	OR PARTITION, W/ STUDS @ 5/8" F.C. GYP. BD ON UND INSULATION.	U3O1	2HR	NOT USED	TYPE C GYP BD
······································	MTL FRAME	@ 16" O.C., 4 LAYER C	ER 5.5" METAL STUDS OF 1/2" F.C. GYP. BD ON 11 FIBERGLASS BATT. INSUL.	U426	3HR	MECH. ACCESS © STAIR TOP ON ROOF	TYPE C GYP BD
······································	MTL FRAME	@ 16" O.C., 2 LAYER C	ER 5.5" METAL STUDS DF 1/2" F.C. GYP. BD ON 1 FIBERGLASS BATT. INSUL.	U419	2HR	INTERIOR DECKS	TYPE C GYP BD
	DOOR	STANDARD WOOD OR	METAL DOOR	N/A	N/A	N/A	REFER TO DOOR SCHEDULE FOR SIZES & TYPES
	WINDOW	STANDARD ALUMINIUM	1 CLAD WINDOW	N/A	N/A	N/A	REFER TO WINDOW SCHEDULE FOR SIZES & TYPES

N	0	Τ	E	S	
					1

<sup>1.</sup> REFER TO UL BOOK FOR MORE INFORMATION ON THE WALL ASSEMBLIES.

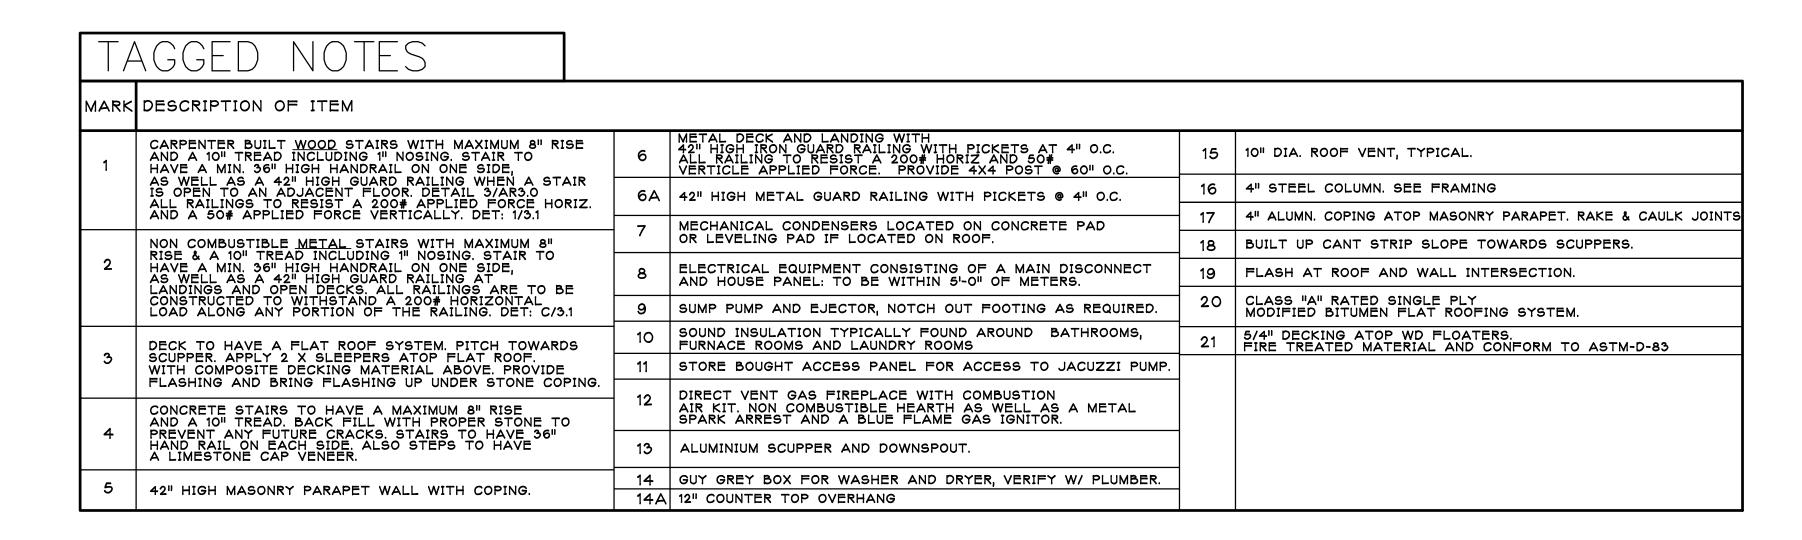

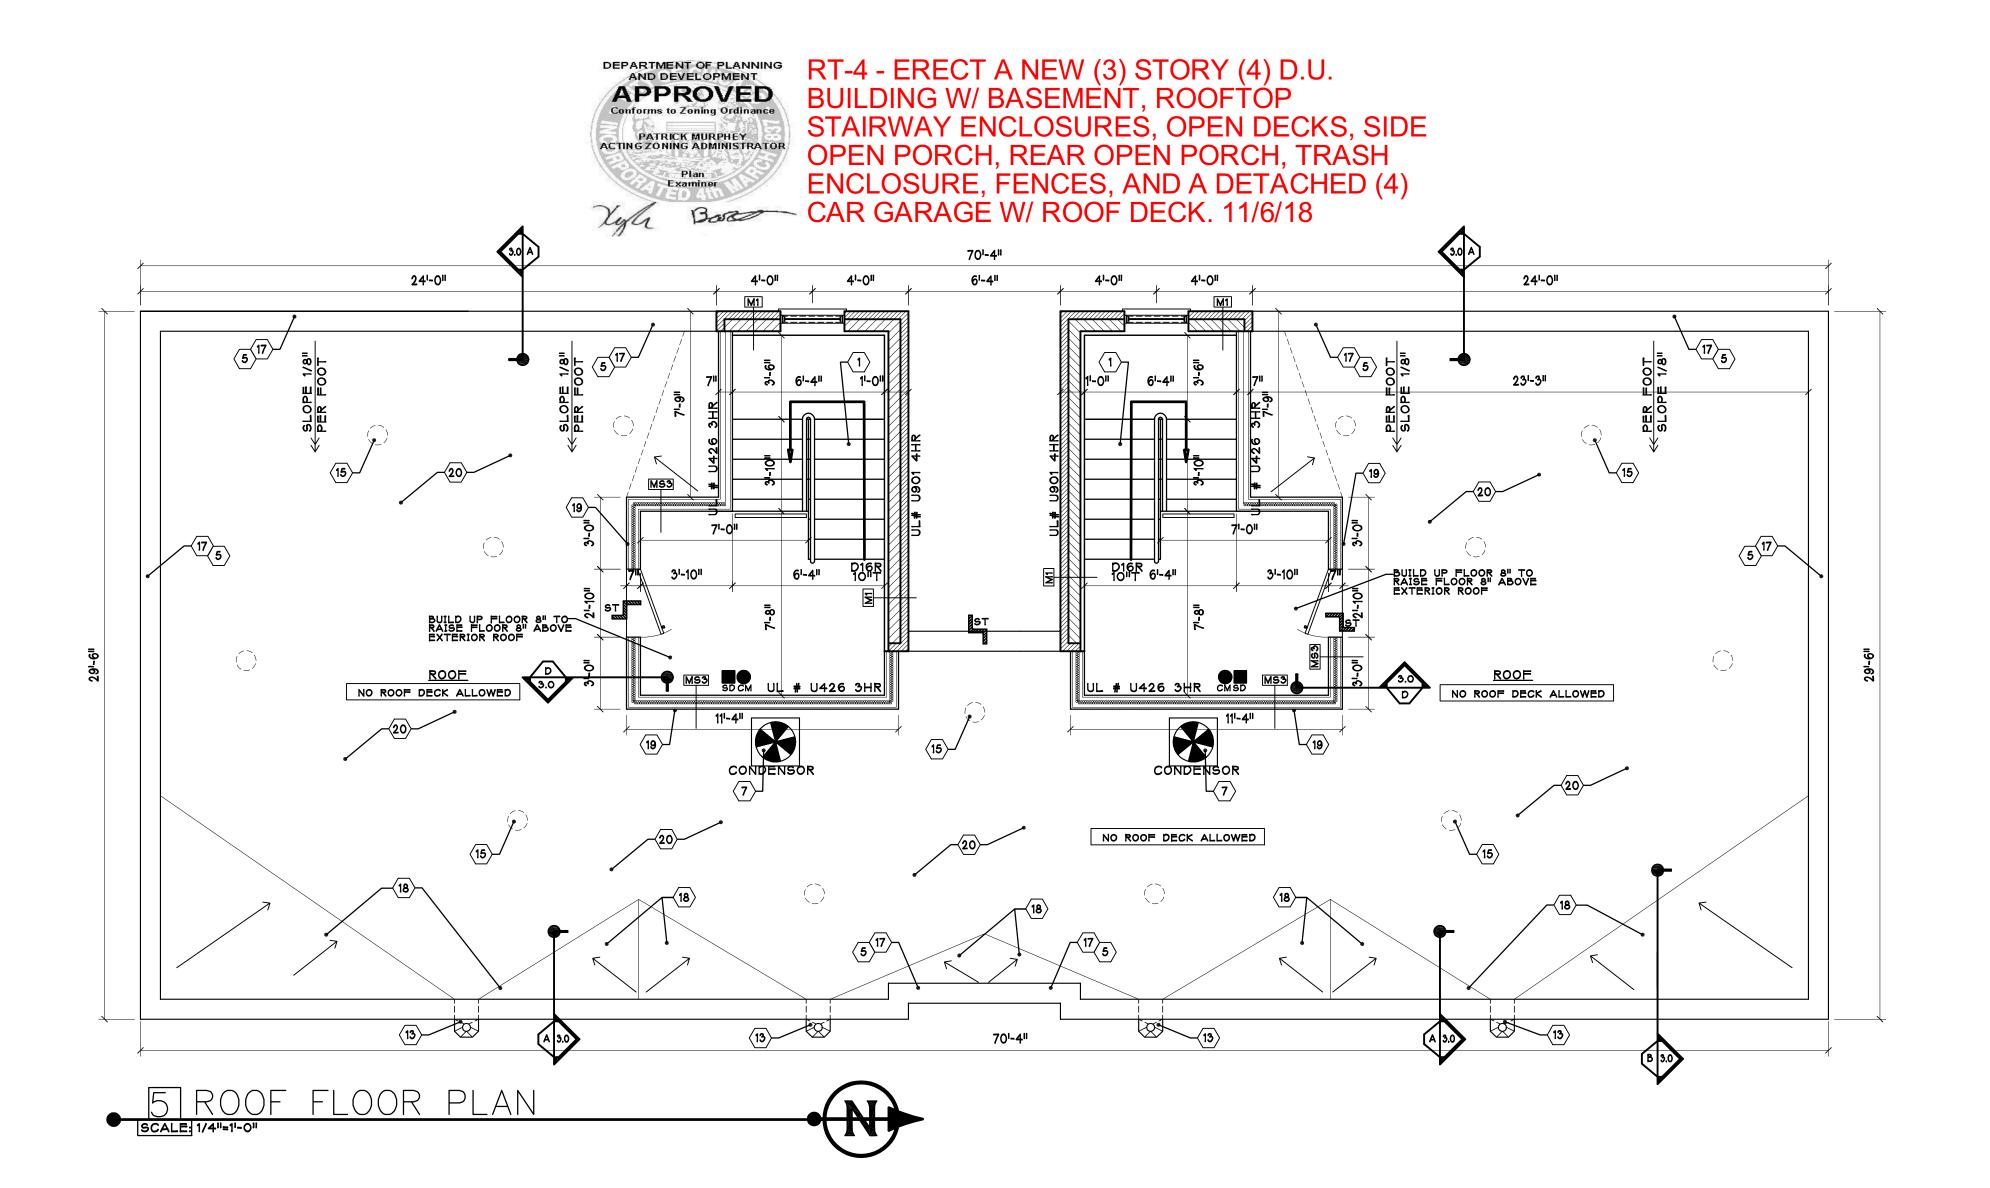

DEPARTMENT OF BUILDINGS

STANDARD PLAN REVIEW


CONDITIONAL

PERMIT

Construction subject to full compliance with the Municipal Code of Chicago and field inspection

Building

SELF CERTIFICATION

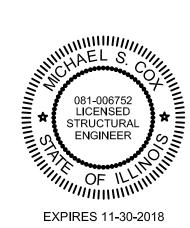

	PERMIT	8/18
No.	Revision/Issue	Date

MC & Associates, LLC

120 W. MADISON SUITE 310 CHICAGO, IL 60602

PROJECT:

ERECT A NEW MASONRY 4 UNIT BUILDING W/ BASEMENT

PROJECT #: DRAWING TITLE:

GP

DATE:

7/18

SCALE:
AS NOTED

DRAWING #:

AR — 1.4

